

NO.	BY	DATE	REVISION DESCRIPTION



COUNTY USE ONLY

ENGINEERING CASE _____
HABITAT CASE _____
PLANNING LAND USE CASE _____
WETLAND CASE _____

Signature NA CLARK COUNTY ENGINEER Date 7/21/16
Signature Clark County Fire Marshal Date 7/15/16
Signature Clark County Environmental Services Date 7/14/16
Resource and Enhancement Permitting
Signature NA Date 7/18/16
Signature Clark County Transportation-Concurrency Date 7/14/16
Signature Clark County Transportation-Signal Date 7/18/16
Signature NA Date 7/20/16
Signature Clark County Transportation-Signing and Striping Date 7/20/16
Signature Clark County Development Engineering Date 7/14/16
Final Site Plan
Signature Clark County Development Engineering Date 7/14/16

- | | | |
|-------------------------------------|-------------------------------------|---|
| A | N/A | |
| <input checked="" type="checkbox"/> | <input checked="" type="checkbox"/> | Stormwater & Erosion Control CCC 40.380 |
| <input checked="" type="checkbox"/> | <input checked="" type="checkbox"/> | Stormwater & Erosion Control CCC 40.385 |
| <input checked="" type="checkbox"/> | <input checked="" type="checkbox"/> | Transportation & Circulation CCC 40.350 |
| <input checked="" type="checkbox"/> | <input checked="" type="checkbox"/> | Within Right-of-Way Landscaping Review |
| <input checked="" type="checkbox"/> | <input checked="" type="checkbox"/> | Utility Permits CCC 13.12A & 12.20A |
| <input checked="" type="checkbox"/> | <input checked="" type="checkbox"/> | Clark County Signing & Striping |
| <input checked="" type="checkbox"/> | <input checked="" type="checkbox"/> | Clark County Traffic Signals |
| <input checked="" type="checkbox"/> | <input checked="" type="checkbox"/> | Road Modifications CCC 40.550.010 |
| <input checked="" type="checkbox"/> | <input checked="" type="checkbox"/> | Critical Aquifer Recharge Areas CCC 40.410 |
| <input checked="" type="checkbox"/> | <input checked="" type="checkbox"/> | Geologic Hazard Areas CCC 40.430 |
| <input checked="" type="checkbox"/> | <input checked="" type="checkbox"/> | Flood Hazard Areas CCC 40.420 |
| <input checked="" type="checkbox"/> | <input checked="" type="checkbox"/> | Sewer and Water Plans |
| <input checked="" type="checkbox"/> | <input checked="" type="checkbox"/> | Clark County M & O Pavement Deflection Testing |
| <input checked="" type="checkbox"/> | <input checked="" type="checkbox"/> | Private Stormwater Covenant |
| <input checked="" type="checkbox"/> | <input checked="" type="checkbox"/> | Grading, Excavation, Fill and Stockpile CCC 14.07 |

RECOMMENDED for APPROVAL
Don Bot FOR A.S. 7/21/16
Engineering Team Leader Date

APPROVED for CONSTRUCTION
Clark County Engineer 7/20/16
Clark County Engineer

Plans Approved for Construction by the County does not in any way relieve the applicant of responsibility to meet all requirements of the County or obligation to protect life, health and property. Plans have been reviewed and approved for compliance with Clark County Code and adopted regulations. Plans shall be revised or supplemented at any time it is determined that the full requirements of the County have not been met.
Rev. 05/14/12

LEWIS RIVER - EAGLE ISLAND
CHUM SPAWNING CHANNEL
WOODLAND, WASHINGTON

LEWIS RIVER - EAGLE ISLAND CHUM SPAWNING CHANNEL DESIGN



DESIGN PROFESSIONAL SHALL COMPLETE ALL LINES:

PROJECT QUANTITIES
N/A = NOT APPLICABLE √ = APPLICABLE

GRADING:
Onsite Excavation (Cut) Volume (Cubic Yards) 9130 CY
Onsite Fill Volume (Cubic Yards) 2179 CY
Exported Volume (Cubic Yards) 0
Imported Volume (Cubic Yards) 1387 CY
DISTURBED AREA:
Disturbed Area (Square Feet) 205,522 ft²
FLOW RESTORATION LAND COVER OBLIGATION (TO 0.1 ACRE):
(FOR ONSITE AREAS ONLY AND WHEN MR #7 IS TRIGGERED)
Total Project Area (Acres) N/A
Pre-Development Effective Impervious Area Obligation (Acres) N/A
Pre-Development Lawn/Landscape Obligation (Acres) N/A
Pre-Development Pasture Obligation (Acres) N/A

PUBLIC IMPROVEMENTS	PRIVATE IMPROVEMENTS
<input type="checkbox"/> Transportation (Arterial & Collector) Sidewalk Lineal Feet <u>N/A</u> Curb Lineal Feet <u>N/A</u> Street Lineal Feet <u>N/A</u>	<input type="checkbox"/> Transportation Sidewalk Lineal Feet <u>N/A</u> Curb Lineal Feet <u>N/A</u> Street Lineal Feet <u>N/A</u>
<input type="checkbox"/> Transportation (Other) Sidewalk Lineal Feet <u>N/A</u> Curb Lineal Feet <u>N/A</u> Street Lineal Feet <u>N/A</u>	
<input type="checkbox"/> Stormwater Facility Type <u>N/A</u>	<input type="checkbox"/> Stormwater Facility Type <u>N/A</u>

SHEET INDEX

- Cover, Sheet Index, and Vicinity Map
- General Notes
- Erosion Control Notes
- Erosion Control Details
- Summary of Quantities and Material Specifications
- Existing Conditions, Ownership, and Survey Control
- Preliminary Development Plan (Access, Staging & Erosion Control)
- Erosion and Sedimentation Control Typical Details
- Sheet Index and Proposed Conditions Plan & Profile
- Proposed Conditions STA 0+10 to 3+25
- Proposed Conditions STA 3+50 to 10+25
- Proposed Conditions STA 10+25 to 13+70
- Grading Cross-Sections STA 1+00 to 13+00
- Control Weir Cross Sections
- Typical Details
- Control Weir Typical Details
- Typical Details
- Typical Details
- Typical Details
- Revegetation Plan





COVER, SHEET INDEX,
AND VICINITY MAP

SHEET
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JUL 21 2016

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- LEGEND**
- CP600 SURVEY CONTROL POINT
 - ORDINARY HIGH WATER
 - EDGE OF EXISTING FLOODPLAIN
 - EXISTING CONTOURS (1FT INTERVALS)
 - PROPERTY LINES
 - WETLAND - PALUSTRINE FORESTED (43,356 SQUARE FEET)
 - EXISTING TREES

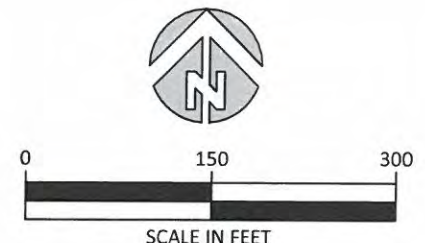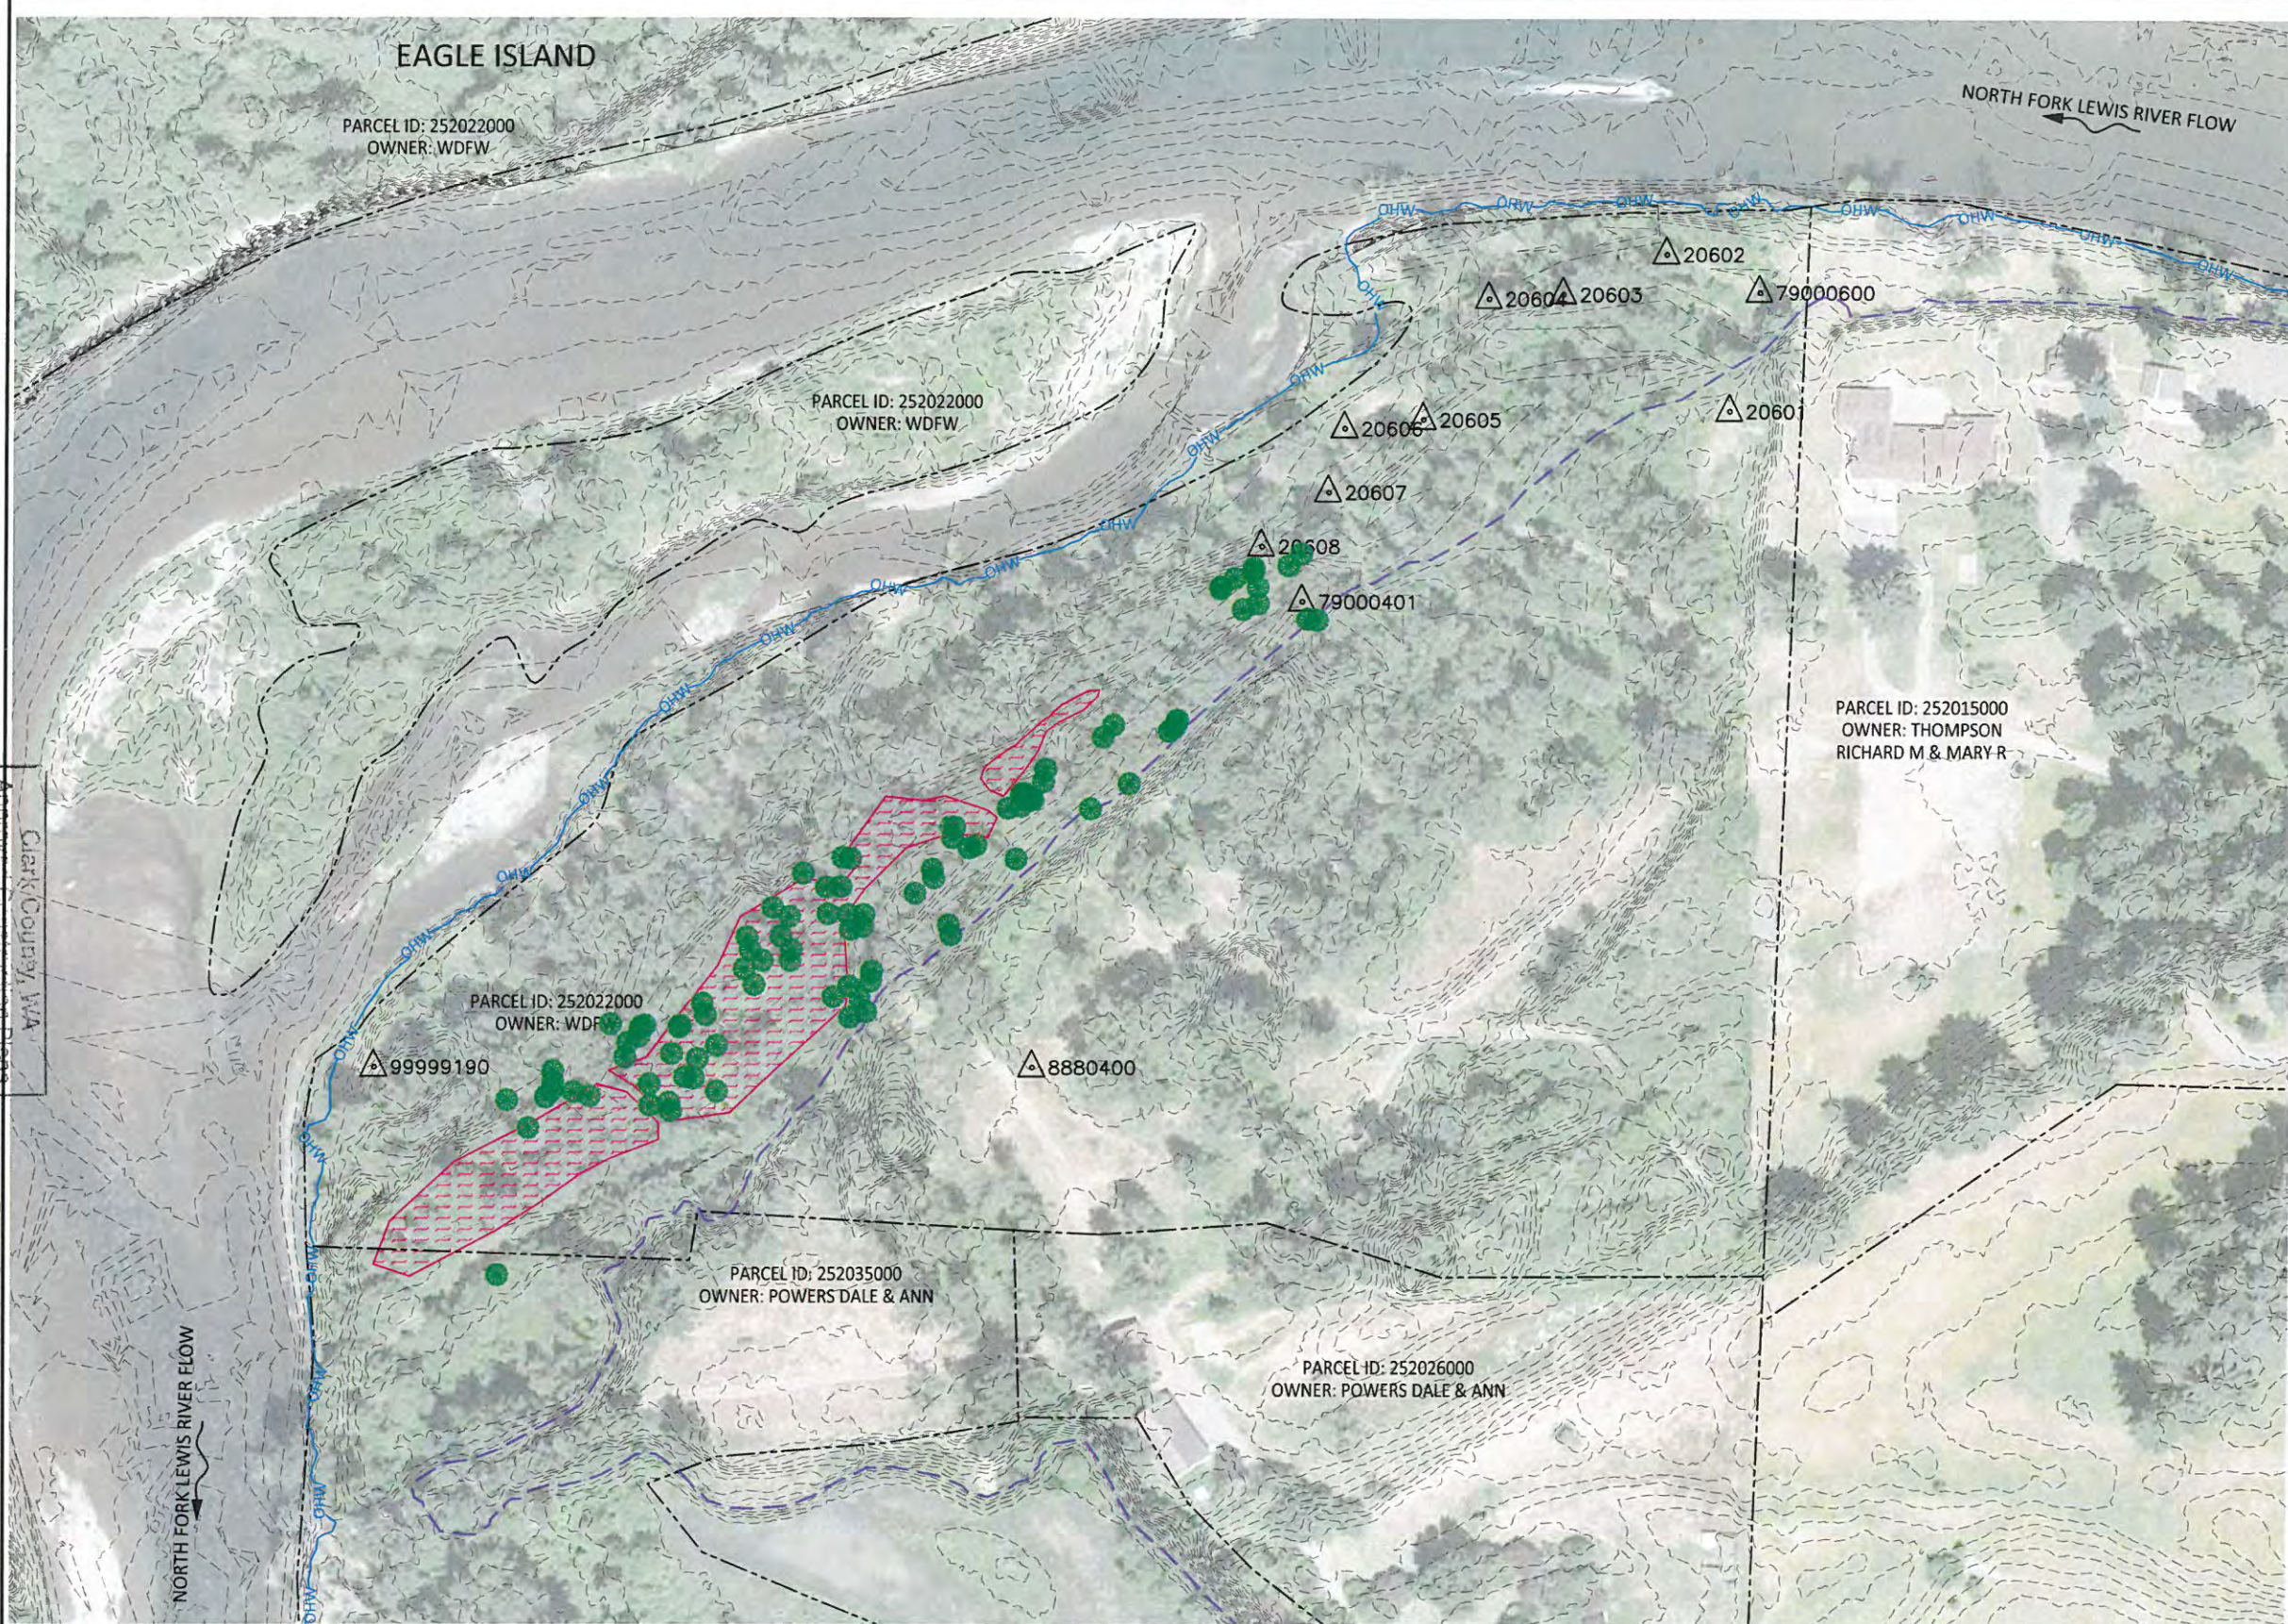

SURVEY CONTROL

POINT #	NORTHING	EASTING	ELEV.	DESC.
20601	227958.97	1084979	35.3348	cp601
20602	228093.074	1084924	31.9128	cp602
20603	228058.741	1084836	31.7898	cp603
20604	228054.871	1084772	31.0508	cp604
20605	227951.448	1084717	31.7058	cp605
20606	227943.802	1084650	28.1588	cp606
20607	227889.161	1084636	29.4308	cp607
20608	227842.826	1084580	33.5998	cp608
8880400	227397.62	1084388	37.5886	cp400
79000401	227795.747	1084615	29.0248	cp401
79000600	228060.609	1085003	31.3948	CP600
79000601	227958.951	1084979	35.2958	cp601
99999190	227397.76	1083826	28.9528	cp90

SITE PLAN

				MJ,DF DRAWN	MM,GJ DESIGNED	GJ CHECKED
				MM	7/07/16	11-02-07
				APPROVED	DATE	PROJECT
NO.	BY	DATE	REVISION DESCRIPTION			


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CHUM SPAWNING CHANNEL
WOODLAND, WASHINGTON

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EXISTING CONDITIONS, OWNERSHIP, AND SURVEY CONTROL	SHEET
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Clark County, WA



SITE PLAN

NOTES:

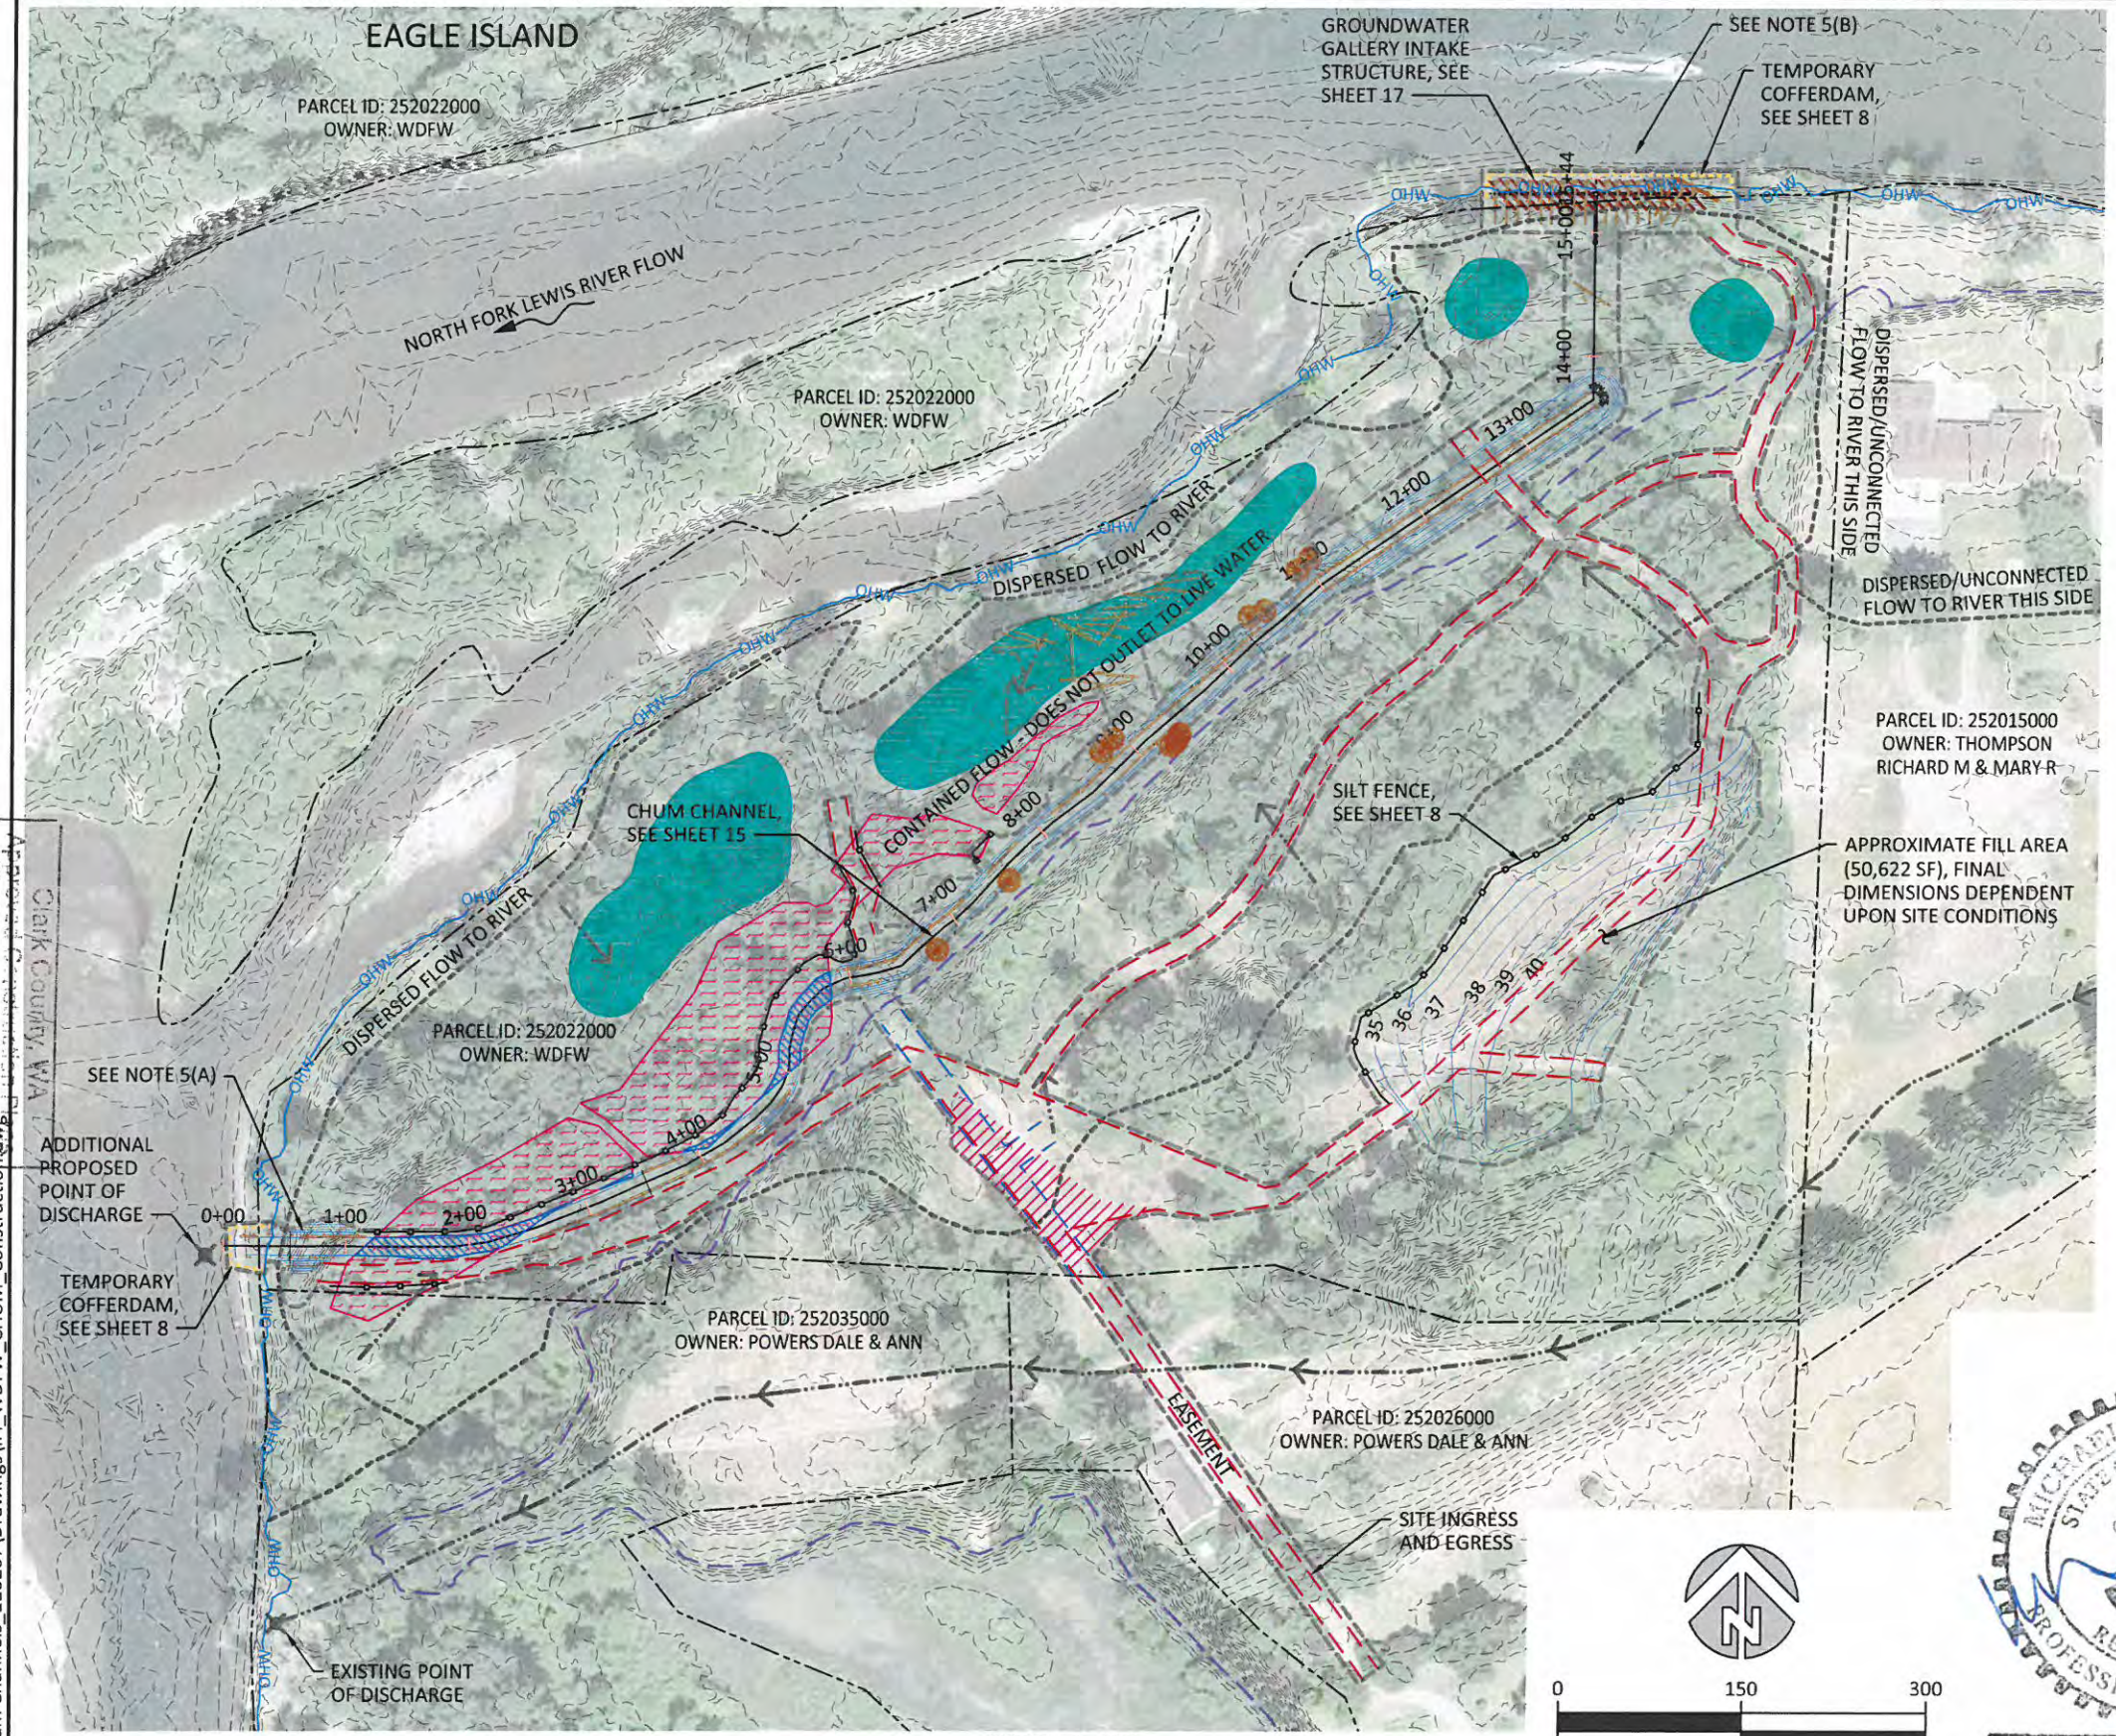1. EXISTING FLOW PATHS WILL NOT BE ALTERED BY PROJECT. EXISTING AND PROPOSED WILL BE THE SAME EXCEPT FOR EXISTING CAPTURED FLOWS. DURING CONSTRUCTION, THEY WILL BE TREATED IN THE AREA AND RELEASED TO THE RIVER. FOLLOWING CONSTRUCTION, CONTAINED FLOW WILL FREELY DRAIN TO THE RIVER.
2. TEMPORARY ROADS WILL BE ABANDONED FOLLOWING CONSTRUCTION. TEMPORARY ROAD FILL PLACEMENT: A MAXIMUM OF 2,000 LF OF 10-12' WIDE ROAD MAY BE ROCKED IF SOIL CONDITIONS/WEATHER DICTATES NECESSARY. UPLAND CONSTRUCTION IS NOT PLANNED TO BEGIN UNTIL THE SITE HAS DRIED OUT (ESTIMATE MAY) TO MINIMIZE ENVIRONMENTAL IMPACTS AND WATER MANAGEMENT/TREATMENT COSTS AND EFFORTS. IN-WATER WORK WILL NOT HAPPEN UNTIL PERMIT WINDOWS (ESTIMATE JULY). IN THE EVENT THAT ANY ROCK IS NEEDED, THE ROAD WILL BE SPOT ROCKED TO FIRM UP SOFT SPOTS. IF THE ENTIRE ROAD WAS TO BE ROCKED, THIS WOULD BE A TOTAL OF 500 CY OF 2-1/2" MINUS (2,000 LF x 12' WIDE x 0.5' DEEP / 27 x 1.15 COMPACTION FACTOR). IT IS HIGHLY UNLIKELY THIS WILL HAPPEN BASED ON SITE OBSERVATIONS. IT IS MORE PROBABLE THAT SOME AREAS (20-50' LONG) MAY RECEIVE MORE THAN 6" OF ROCK ON THEM. ALL TEMPORARY ROCK FILL WILL BE REMOVED AT THE CONCLUSION OF THE WORK BACK DOWN TO EXISTING SOILS TO ENCOURAGE REVEGETATION AND PRESERVE NATURAL DRAINAGE PATHS, AND MINIMIZE IMPERMEABLE SURFACE AREA.
3. ADDITIONALLY, THE EXCAVATED CHANNEL WILL BE USED AS A TEMPORARY ROADWAY.
4. PLANNED ROAD FILL PERMANENT: THE STAGING AREA WILL RECEIVE 6" OF 2-1/2" MINUS GRAVEL TO FACILITATE STAGING OF MATERIALS IN THE SPRING. ESTIMATED QUANTITY 300CY.
5. CHANNEL IS TO BE CONSTRUCTED IN RELIC CHANNEL OF LEWIS RIVER (CIRCA 1950s). THERE ARE NATURAL LEVEES ON BOTH ENDS OF OF THE CHANNEL CURRENTLY. THE DOWNSTREAM (A) LEVEE WILL BE BREACHED. THE UPSTREAM END (B) WILL BE REBUILT.

LEGEND

- OHW — ORDINARY HIGH WATER
- - - EXISTING CONTOURS (1FT INTERVALS)
- - - PROPOSED CONTOURS (1FT INTERVALS)
- - - PROPERTY LINES
- - - EDGE OF EXISTING FLOODPLAIN
- - - LIMITS OF DISTURBANCE
- [Pattern] WETLAND - PALUSTRINE FORESTED (43,356 SQUARE FEET)
- [Pattern] IMPACTED WETLAND (3882 SF, 288 CY)
- [Pattern] POTENTIAL VEGETATIVE FILTRATION ZONE
- [Pattern] TEMPORARY STAGING / STOCKPILE AREA
- [Pattern] TEMPORARY COFFERDAM
- [Symbol] SILT FENCE
- [Pattern] CLEARED, EXISTING VEHICLE TRAILS TO BE USED AS TEMPORARY ROADS (SEE NOTE 4)
- [Pattern] PROPOSED PERMANENT ACCESS ROAD AND PARKING AREA (SEE NOTE 3)
- - - THRESHOLD DRAINAGE AREA (TDA) BOUNDARY
- - - TDA FLOW PATH



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				DRAWN	DESIGNED	CHECKED
				MM	7/07/16	11-02-07
				APPROVED	DATE	PROJECT

LEWIS RIVER - EAGLE ISLAND
CHUM SPAWNING CHANNEL
WOODLAND, WASHINGTON


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PRELIMINARY DEVELOPMENT
PLAN (ACCESS, STAGING &
EROSION CONTROL)

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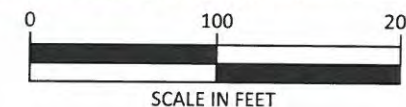
LEGEND

- OHW — ORDINARY HIGH WATER
- - - EXISTING CONTOURS (1FT INTERVALS)
- - - PROPOSED CONTOURS (1FT INTERVALS)
- - - PROPERTY LINES
- - - LIMITS OF DISTURBANCE
- - - TEMPORARY COFFERDAM
- EXISTING TREES TO REMAIN
- EXISTING TREES TO BE REMOVED


PLAN

TEN EXISTING TREES TO BE REMOVED AND SALVAGED. REMOVED TREES SHALL BE USED IN LOG STRUCTURE OR FLOODPLAIN WOOD AT LOCATIONS SPECIFIED BY OWNER.

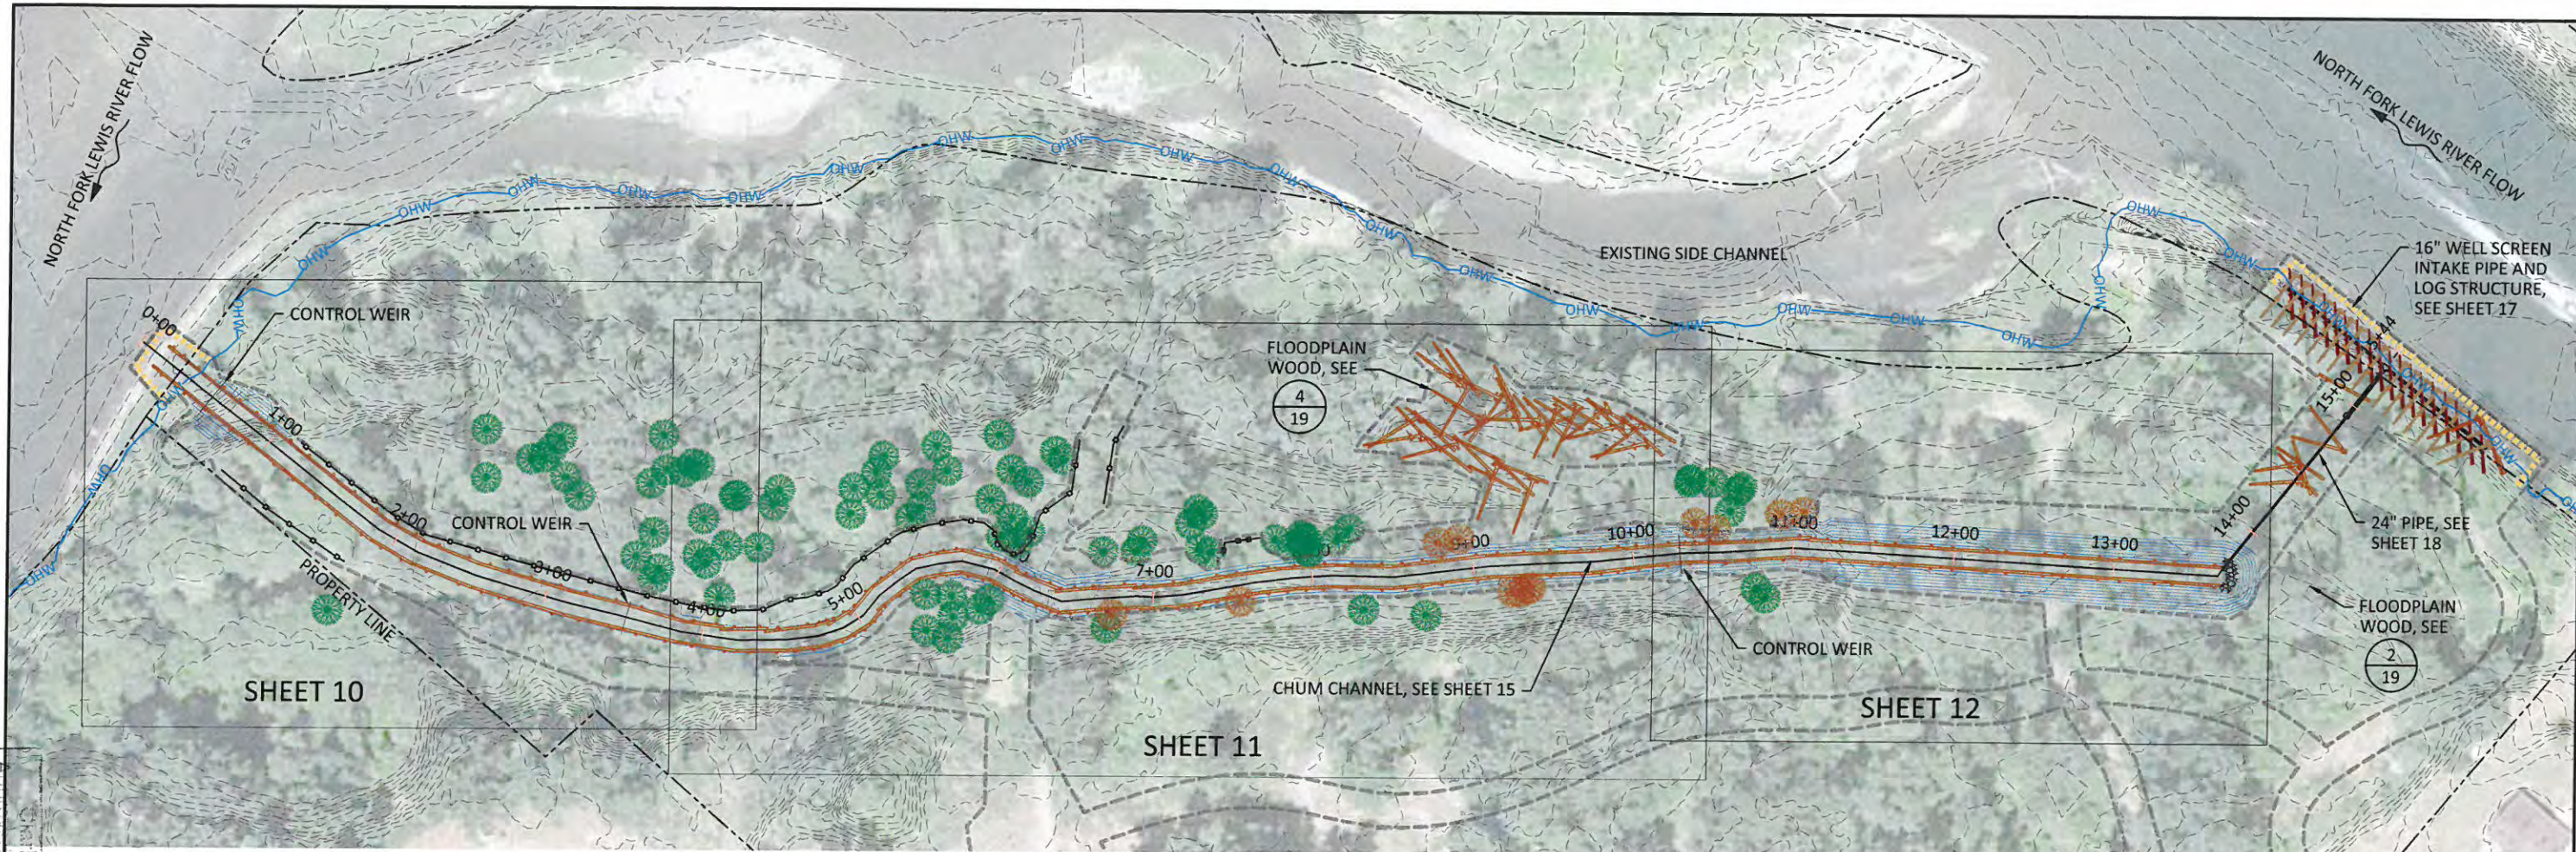EROSION CONTROL INSPECTION REQUIRED
CALL 397-2375 EXT. 2499
BEFORE YOU BEGIN ANY SITWORK



PROFILE

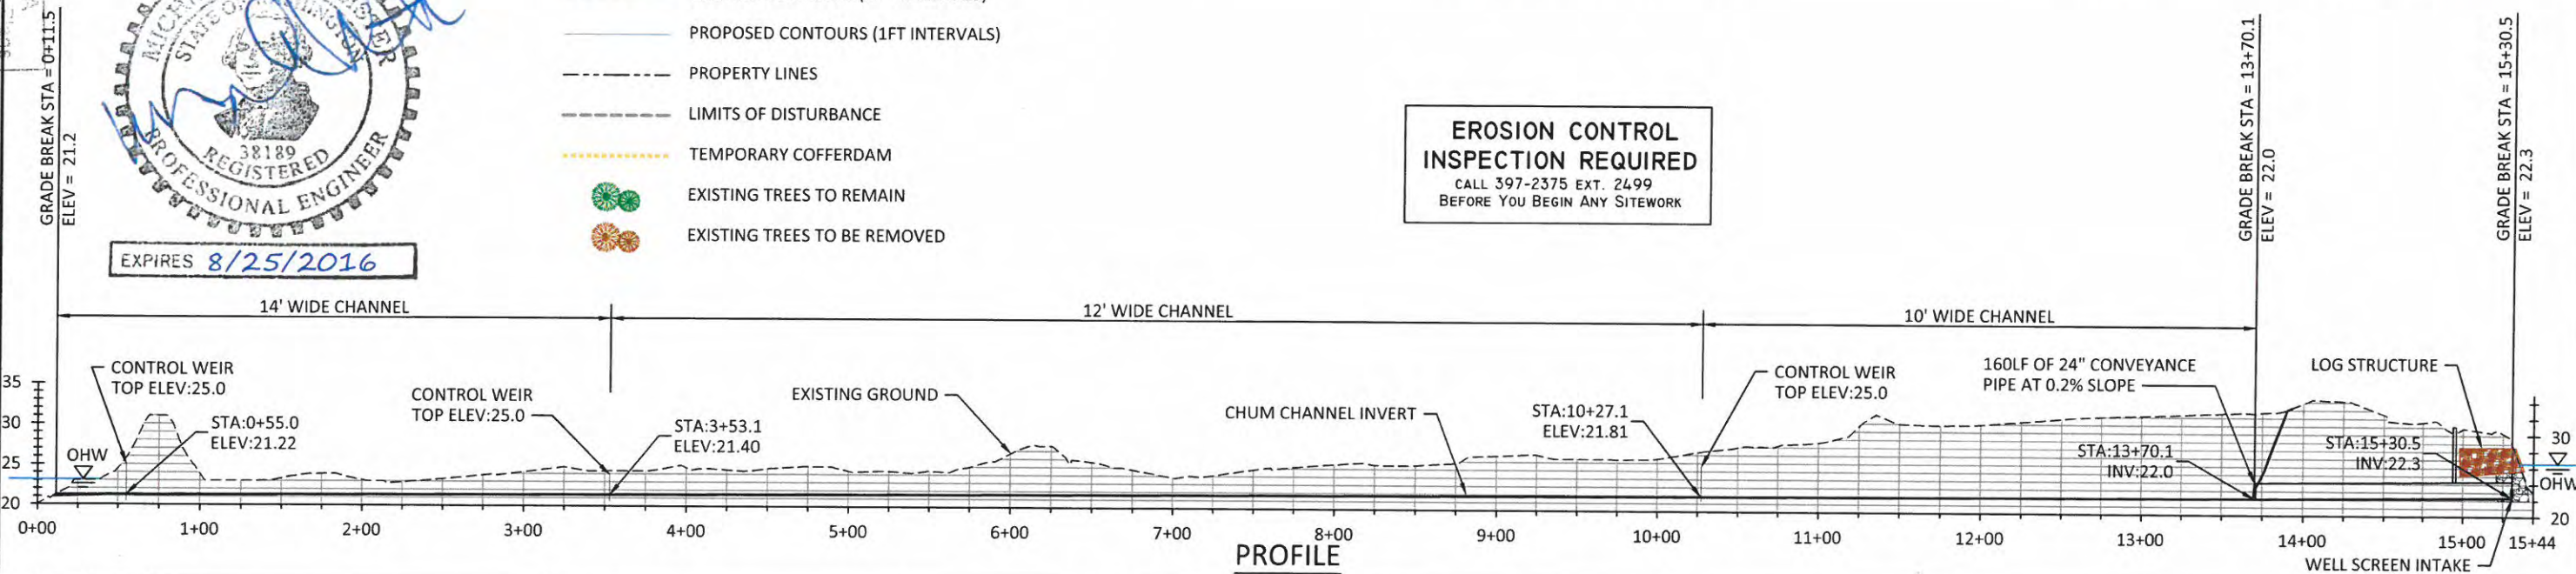


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SHEET INDEX AND PROPOSED
CONDITIONS PLAN & PROFILE

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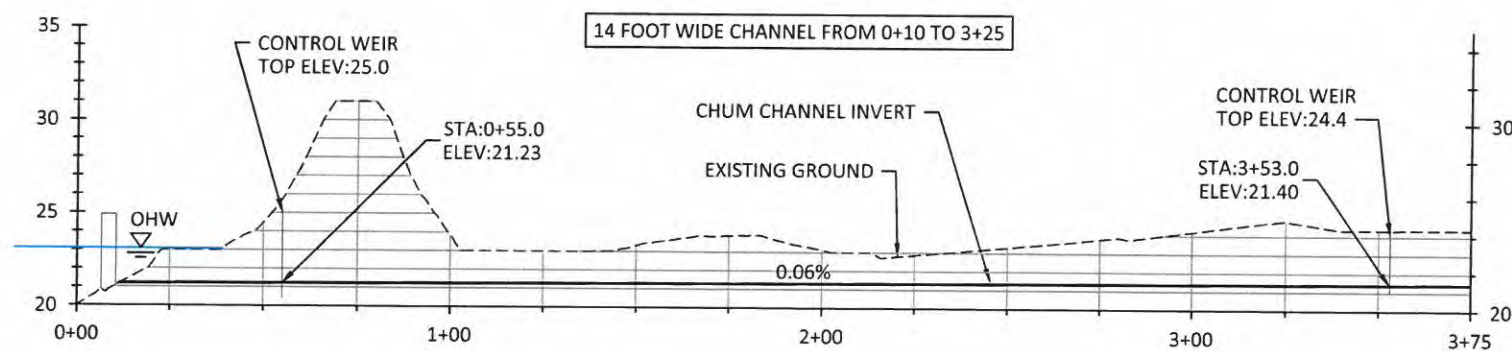
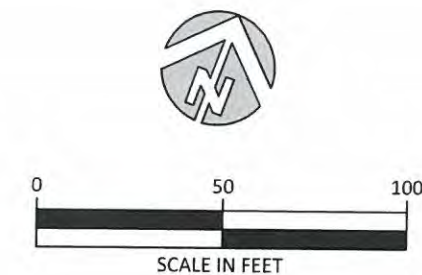


PLAN

SEE SHEET 13 FOR GRADING CROSS SECTIONS.


LEGEND

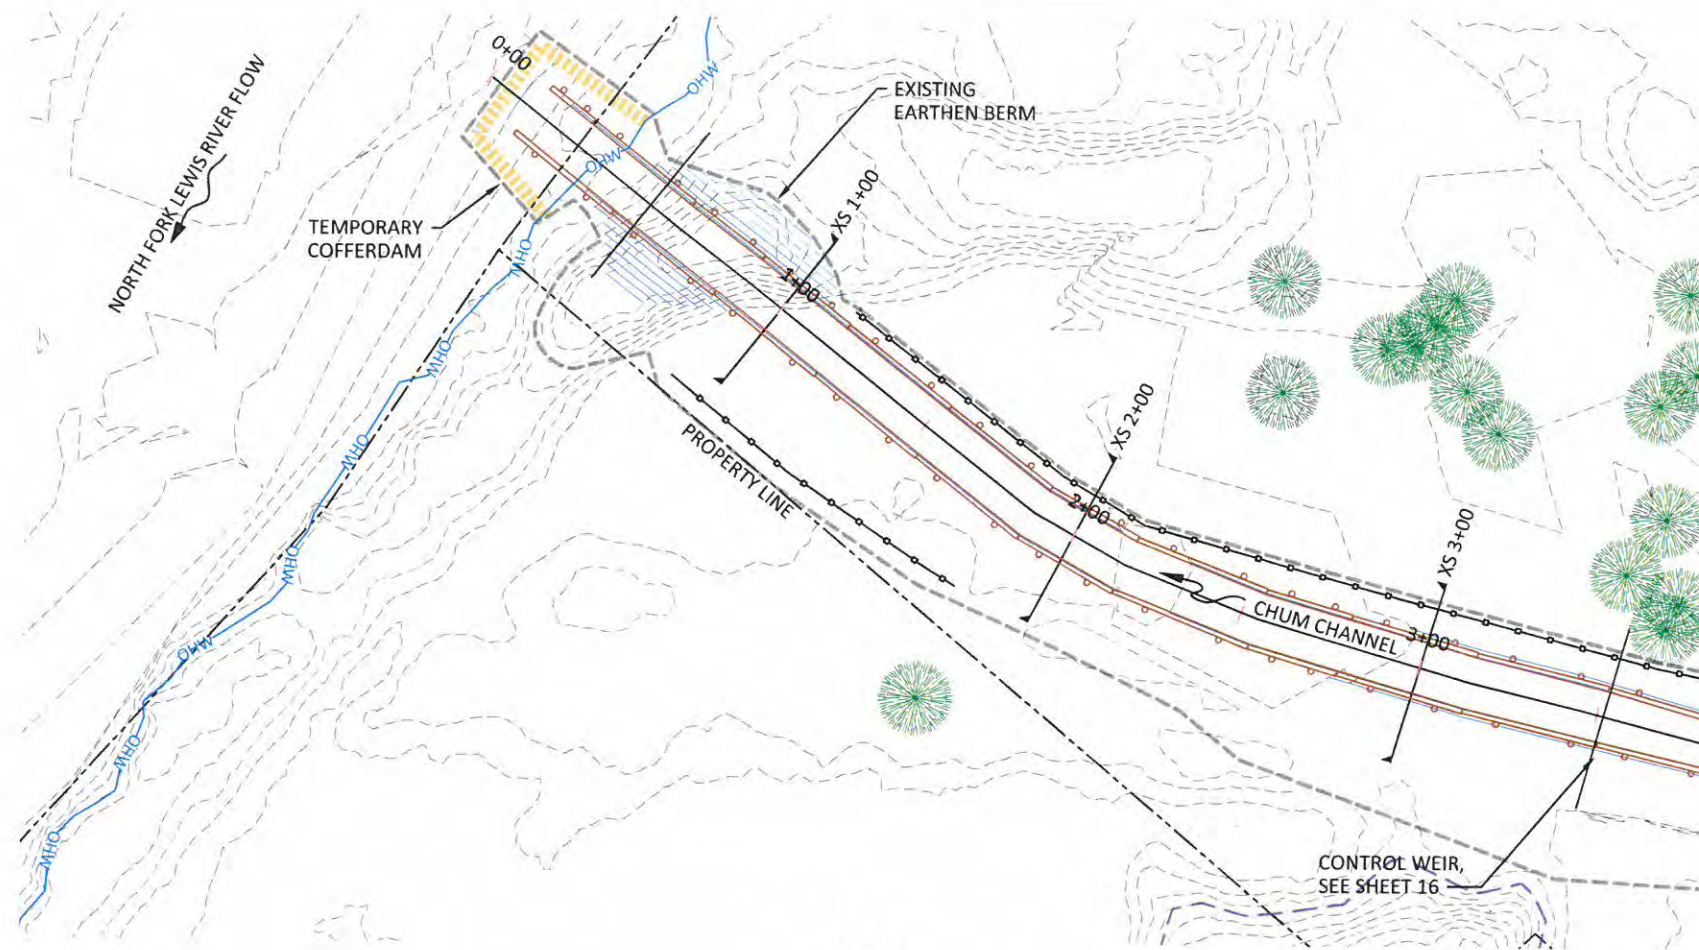- ORDINARY HIGH WATER
- EDGE OF EXISTING FLOODPLAIN
- EXISTING CONTOURS (1FT INTERVALS)
- PROPOSED CONTOURS (1FT INTERVALS)
- PROPERTY LINES
- LIMITS OF DISTURBANCE
- TEMPORARY COFFERDAM
- XS 3+00 GRADING CROSS SECTIONS, SEE SHEET 13
- EXISTING TREES TO REMAIN



PROFILE

**EROSION CONTROL
INSPECTION REQUIRED**
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JUL 21 2016
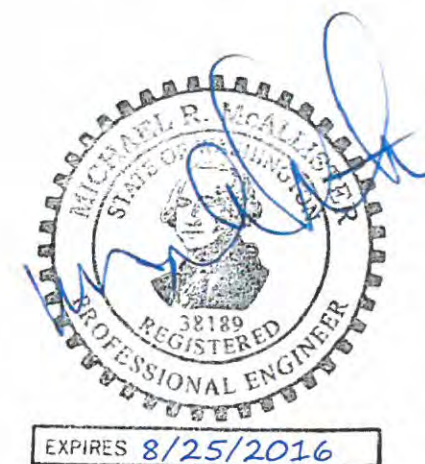
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NO.	BY	DATE	REVISION DESCRIPTION

MJ,DF	MM,GJ	GJ
DRAWN	DESIGNED	CHECKED
MM	7/07/16	11-02-07
APPROVED	DATE	PROJECT

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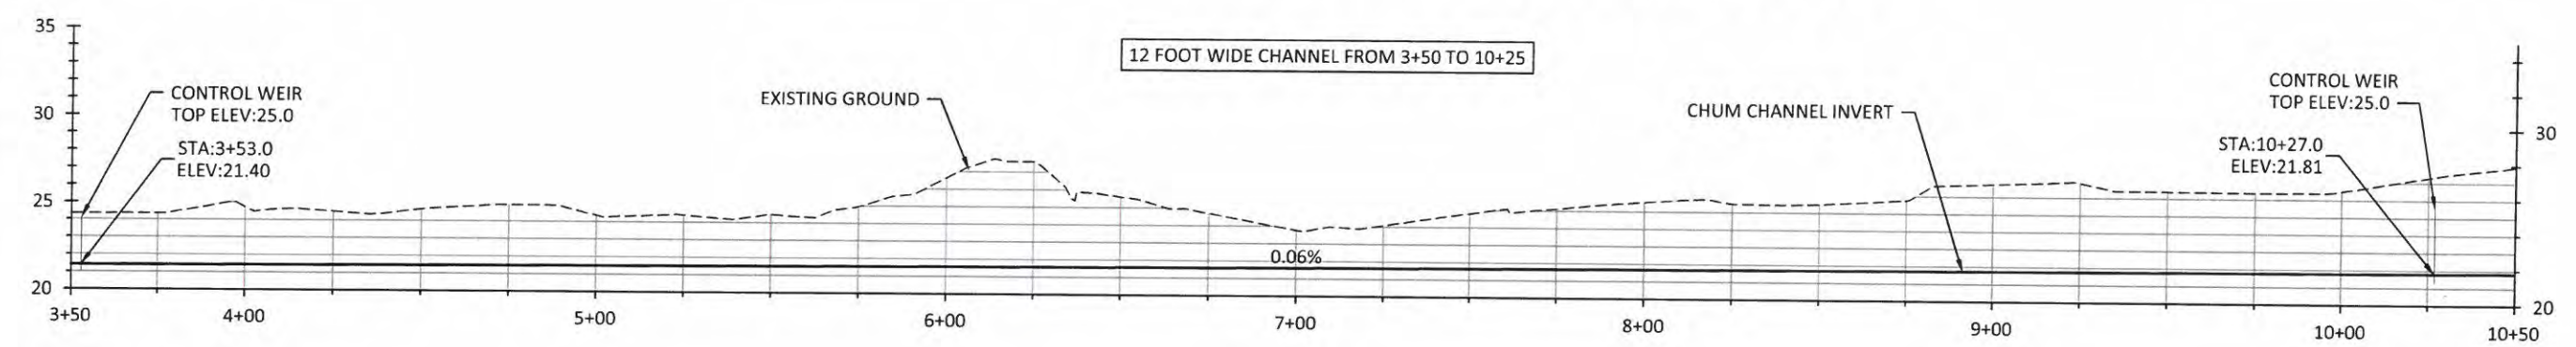
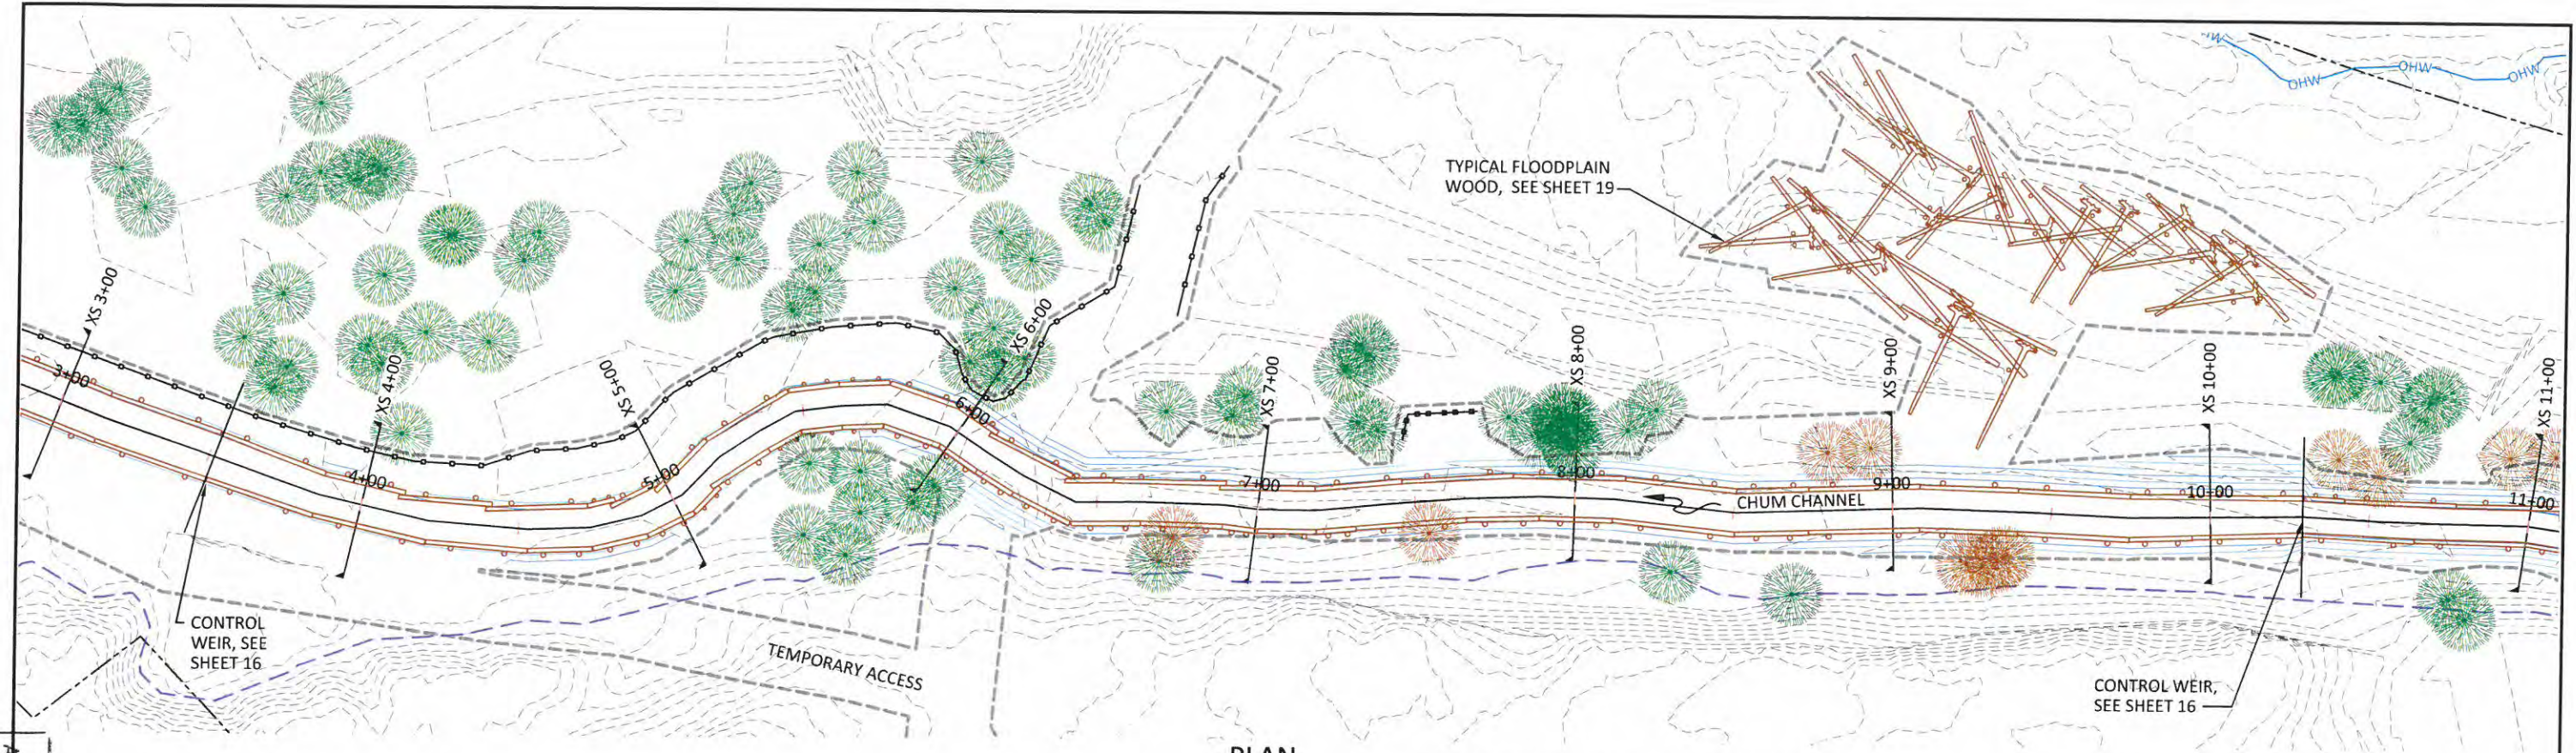
PROPOSED CONDITIONS
STA 0+10 TO 3+25

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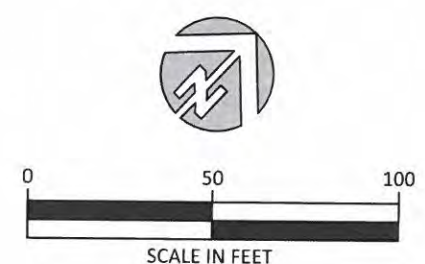
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Approved



LEGEND

- OHW — ORDINARY HIGH WATER
- - - EDGE OF EXISTING FLOODPLAIN
- - - EXISTING CONTOURS (1FT INTERVALS)
- - - PROPOSED CONTOURS (1FT INTERVALS)
- - - PROPERTY LINES
- - - LIMITS OF DISTURBANCE
- XS 3+00 GRADING CROSS SECTIONS, SEE SHEET 13
- EXISTING TREES TO REMAIN
- EXISTING TREES TO BE REMOVED

**EROSION CONTROL
INSPECTION REQUIRED**
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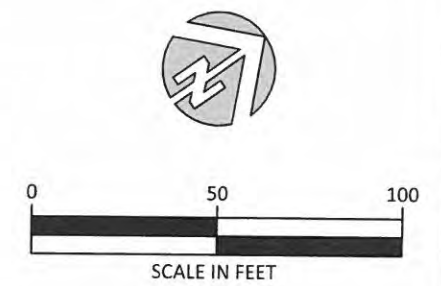
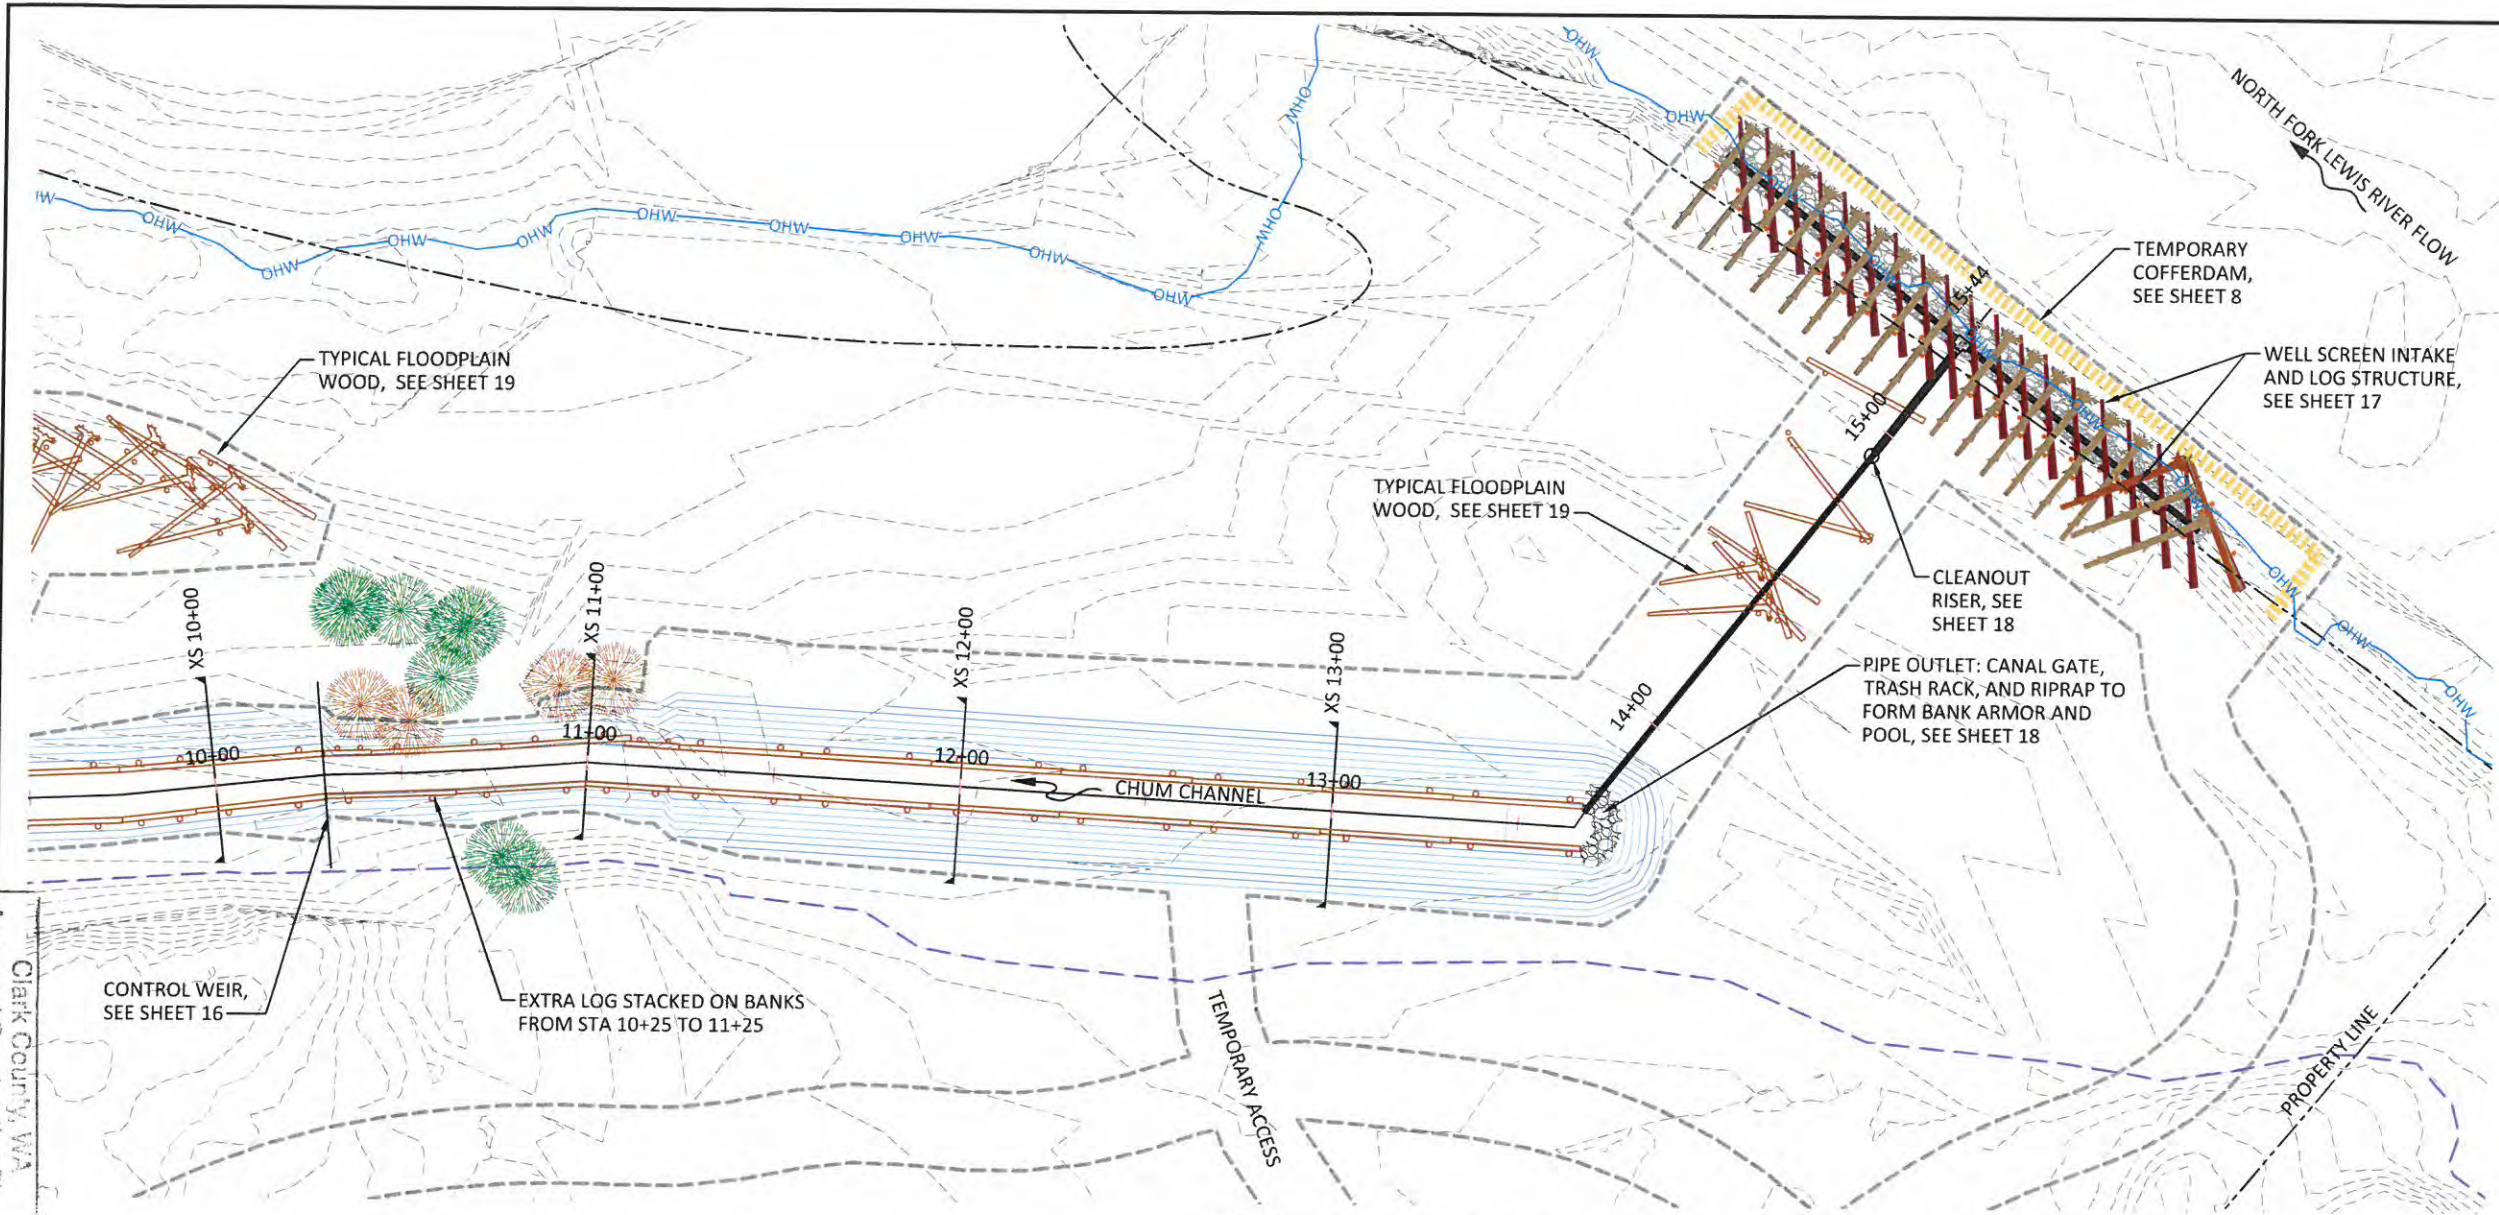
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PROPOSED CONDITIONS
STA 3+50 TO 10+25

SHEET
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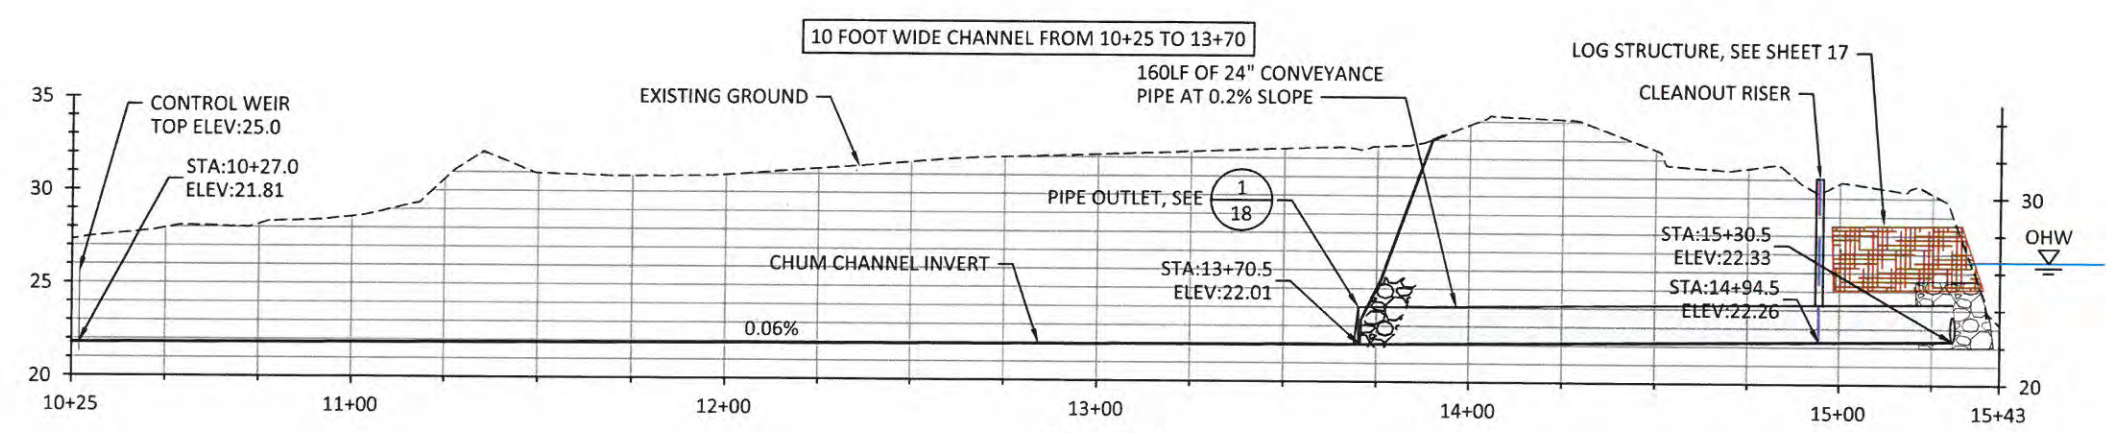
Approved Construction Drawing
Clark County WA
JUL 21 2016
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- LEGEND**
- OHW — ORDINARY HIGH WATER
 - - - EDGE OF EXISTING FLOODPLAIN
 - - - EXISTING CONTOURS (1FT INTERVALS)
 - PROPOSED CONTOURS (1FT INTERVALS)
 - - - PROPERTY LINES
 - - - LIMITS OF DISTURBANCE
 - TEMPORARY COFFERDAM
 - XS 3+00 GRADING CROSS SECTIONS, SEE SHEET 13
 - EXISTING TREES TO REMAIN
 - EXISTING TREES TO BE REMOVED

EROSION CONTROL INSPECTION REQUIRED
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BEFORE YOU BEGIN ANY SITEWORK

PLAN
SEE SHEET 13 FOR GRADING CROSS SECTIONS.



PROFILE



NO.	BY	DATE	REVISION DESCRIPTION

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APPROVED	DATE	PROJECT

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PROPOSED CONDITIONS
STA 10+25 TO 13+70

SHEET
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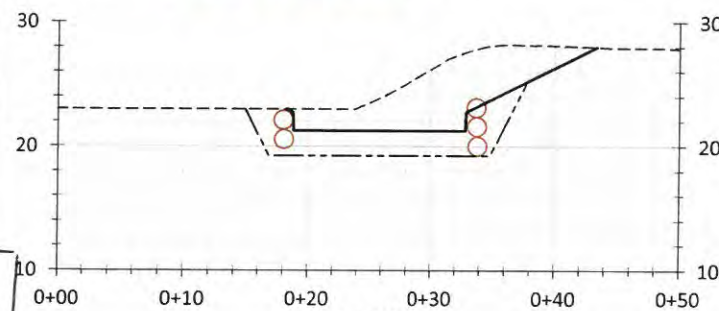


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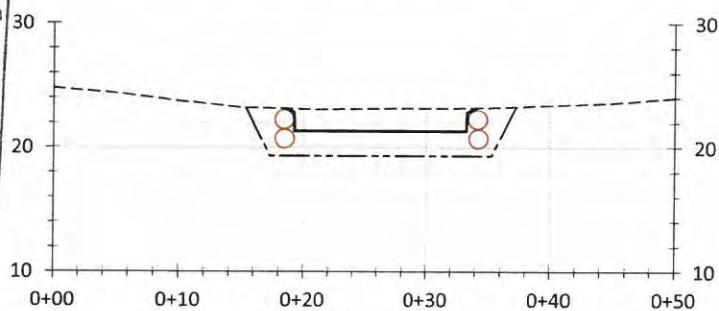
Clark County, WA
Approved Construction Plans

JUL 21 2016


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1+00




2+00




3+00

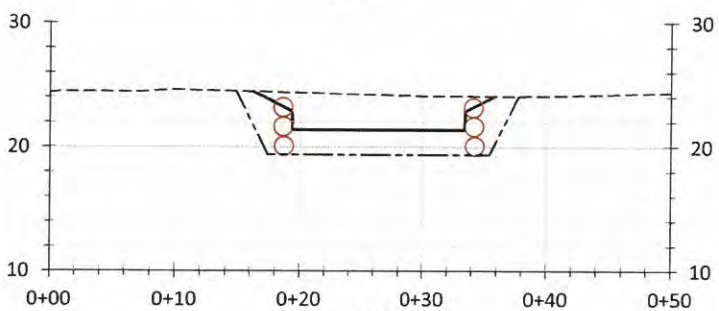
14 FOOT WIDE CHANNEL FROM 0+10 TO 3+25

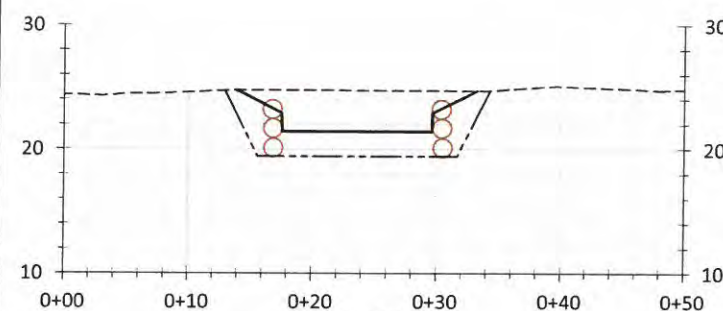


4+00

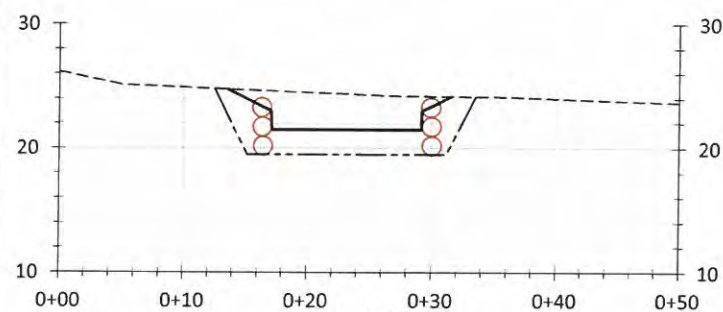

5+00

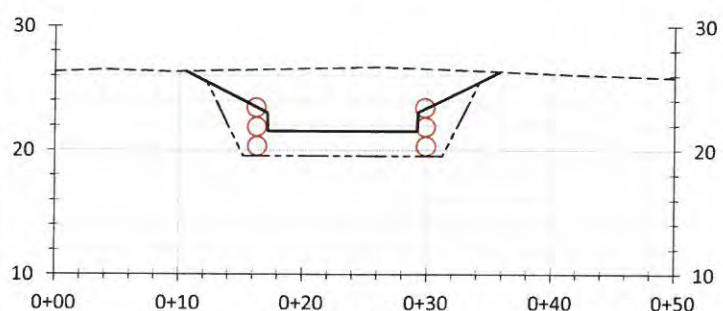



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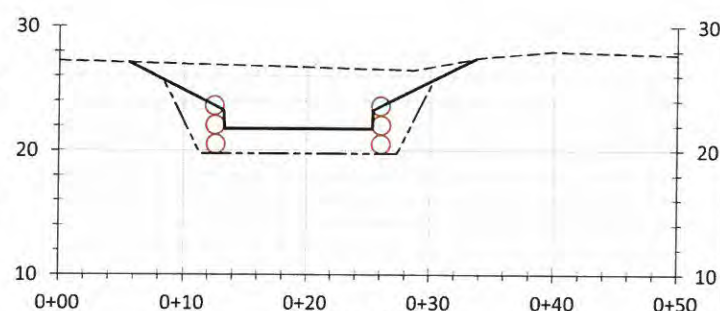
7+00

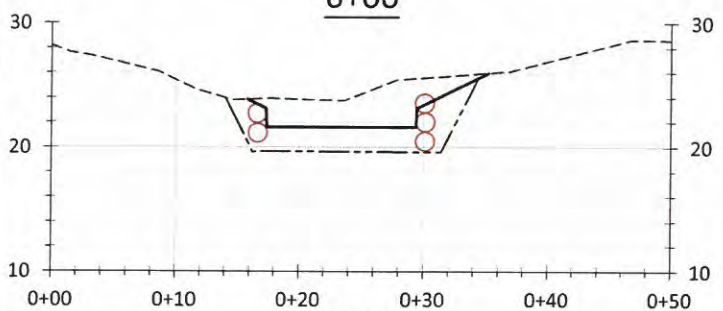LEGEND


--- EXISTING GROUND
— PROPOSED GROUND
--- SUBGRADE



8+00

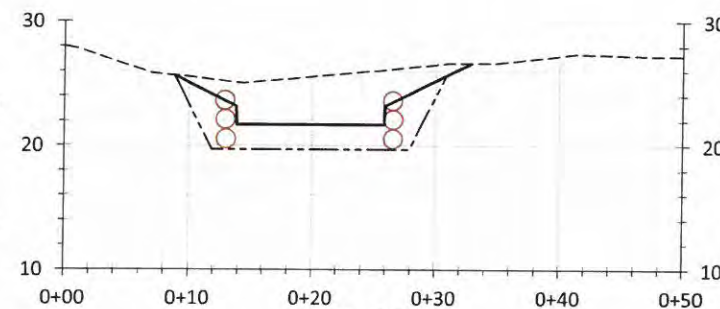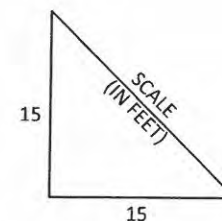


9+00

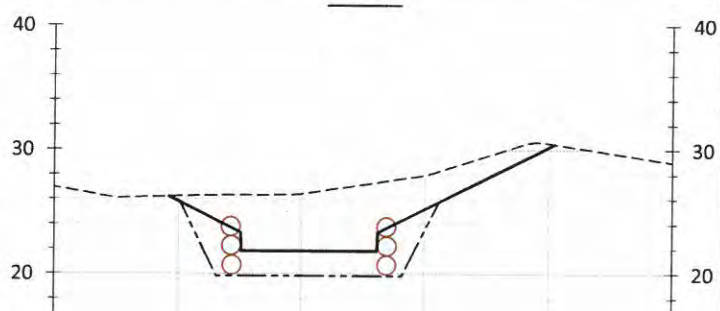


10+00


12 FOOT WIDE CHANNEL FROM 3+50 TO 10+25

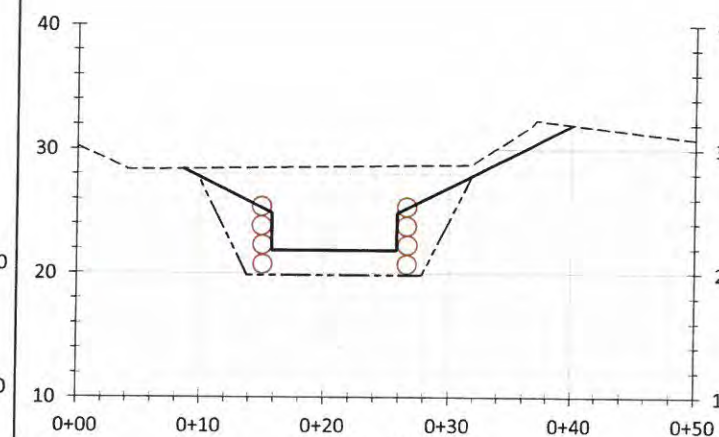

11+00

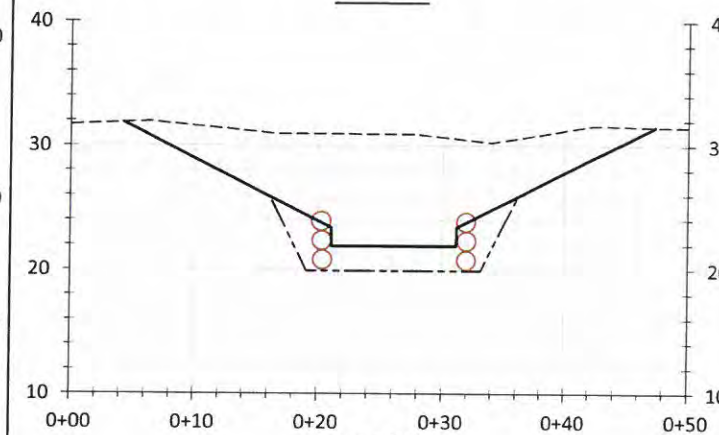

12+00

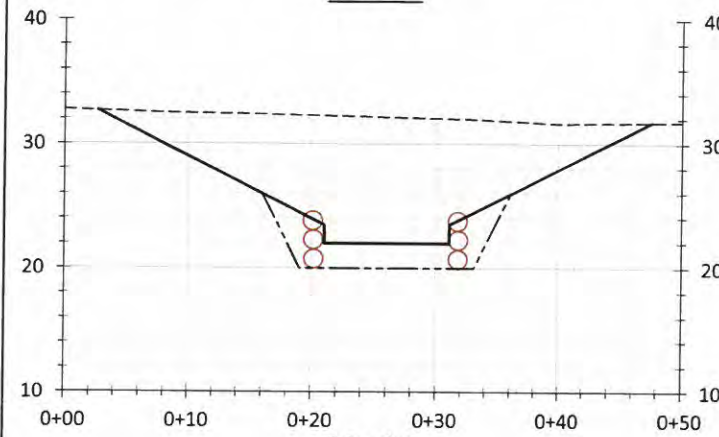

13+00

10 FOOT WIDE CHANNEL FROM 10+25 TO 13+70

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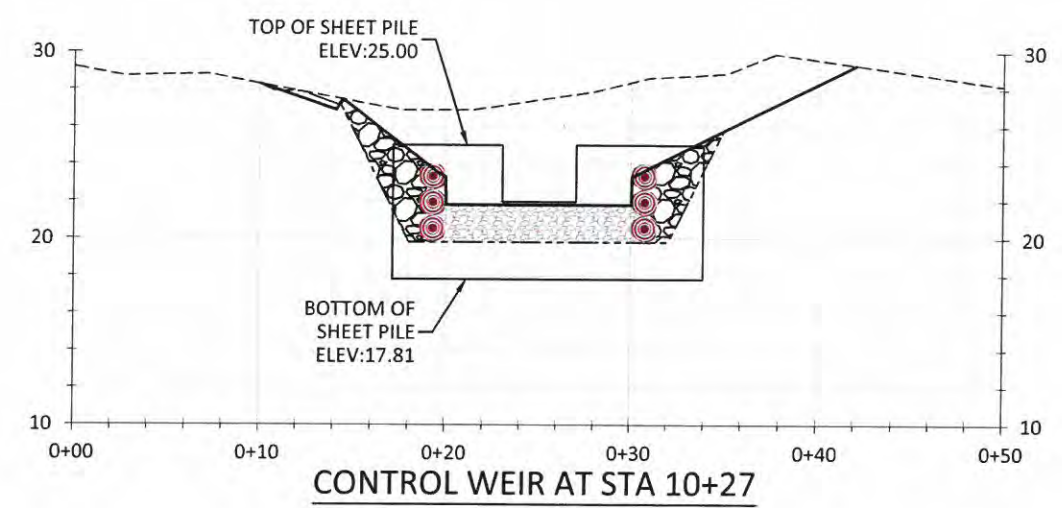
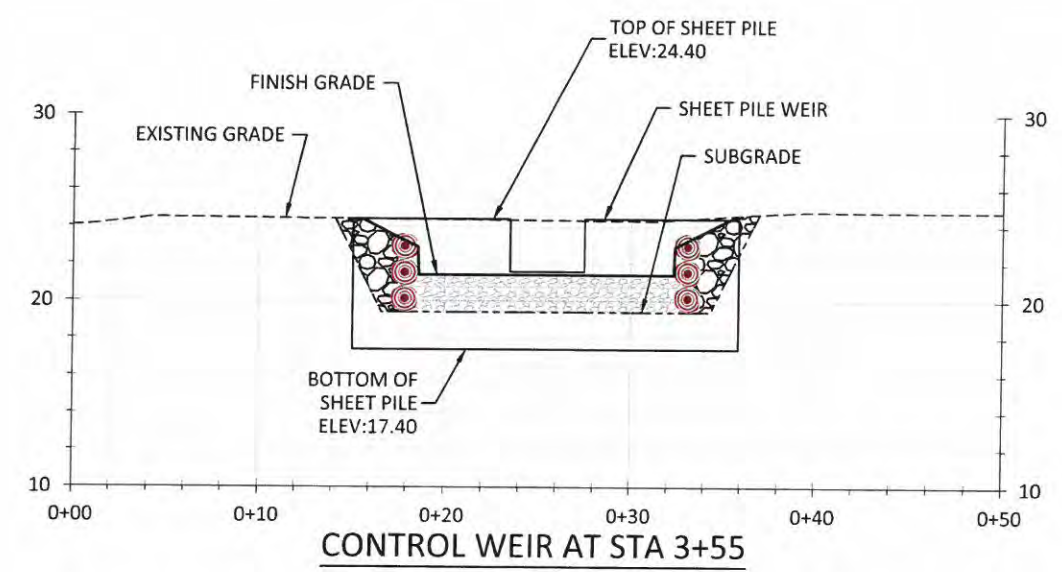
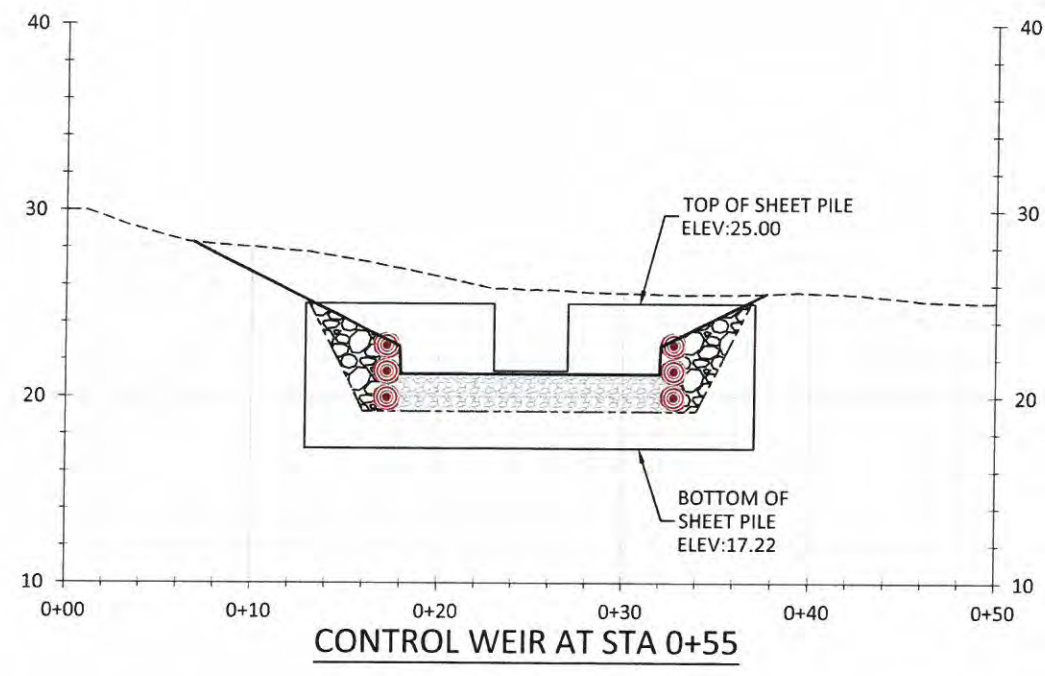
GRADING CROSS-SECTIONS
STA 1+00 TO 13+00

SHEET

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JUL 21 2016
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 Clallam County, WA
 Approved for Construction

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LEGEND

- TOE LOG
- ROCK
- SPAWNING GRAVEL

NOTE: SEE CONTROL WEIR DETAILS ON SHEET 16

SCALE: 1" = 10'
 1x VERTICAL EXAGGERATION
 SCALE: 1" = 10'



NO.	BY	DATE	REVISION DESCRIPTION

MJ,DF	MM,GJ	GJ
DRAWN	DESIGNED	CHECKED
MM	7/07/16	11-02-07
APPROVED	DATE	PROJECT

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CHUM SPAWNING CHANNEL
WOODLAND, WASHINGTON

501 Portway Avenue, Suite 101
 Hood River, OR 97031
 541.386.9003
 www.interfluve.com


CONTROL WEIR CROSS
SECTIONS

SHEET
 14 OF 20


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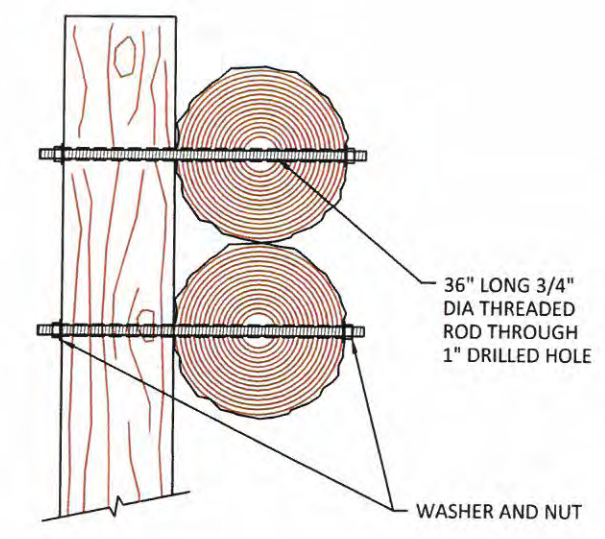
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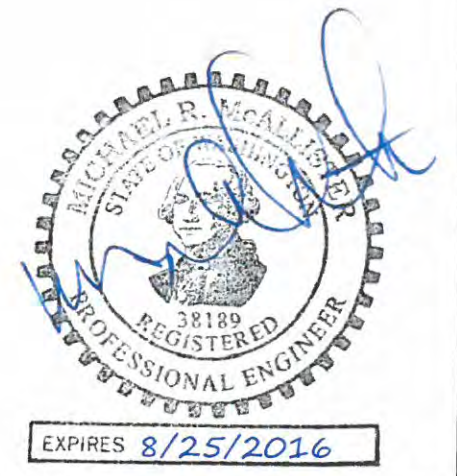
1 TYPICAL PLAN
15 NOT TO SCALE



2 SECTION
15 NOT TO SCALE

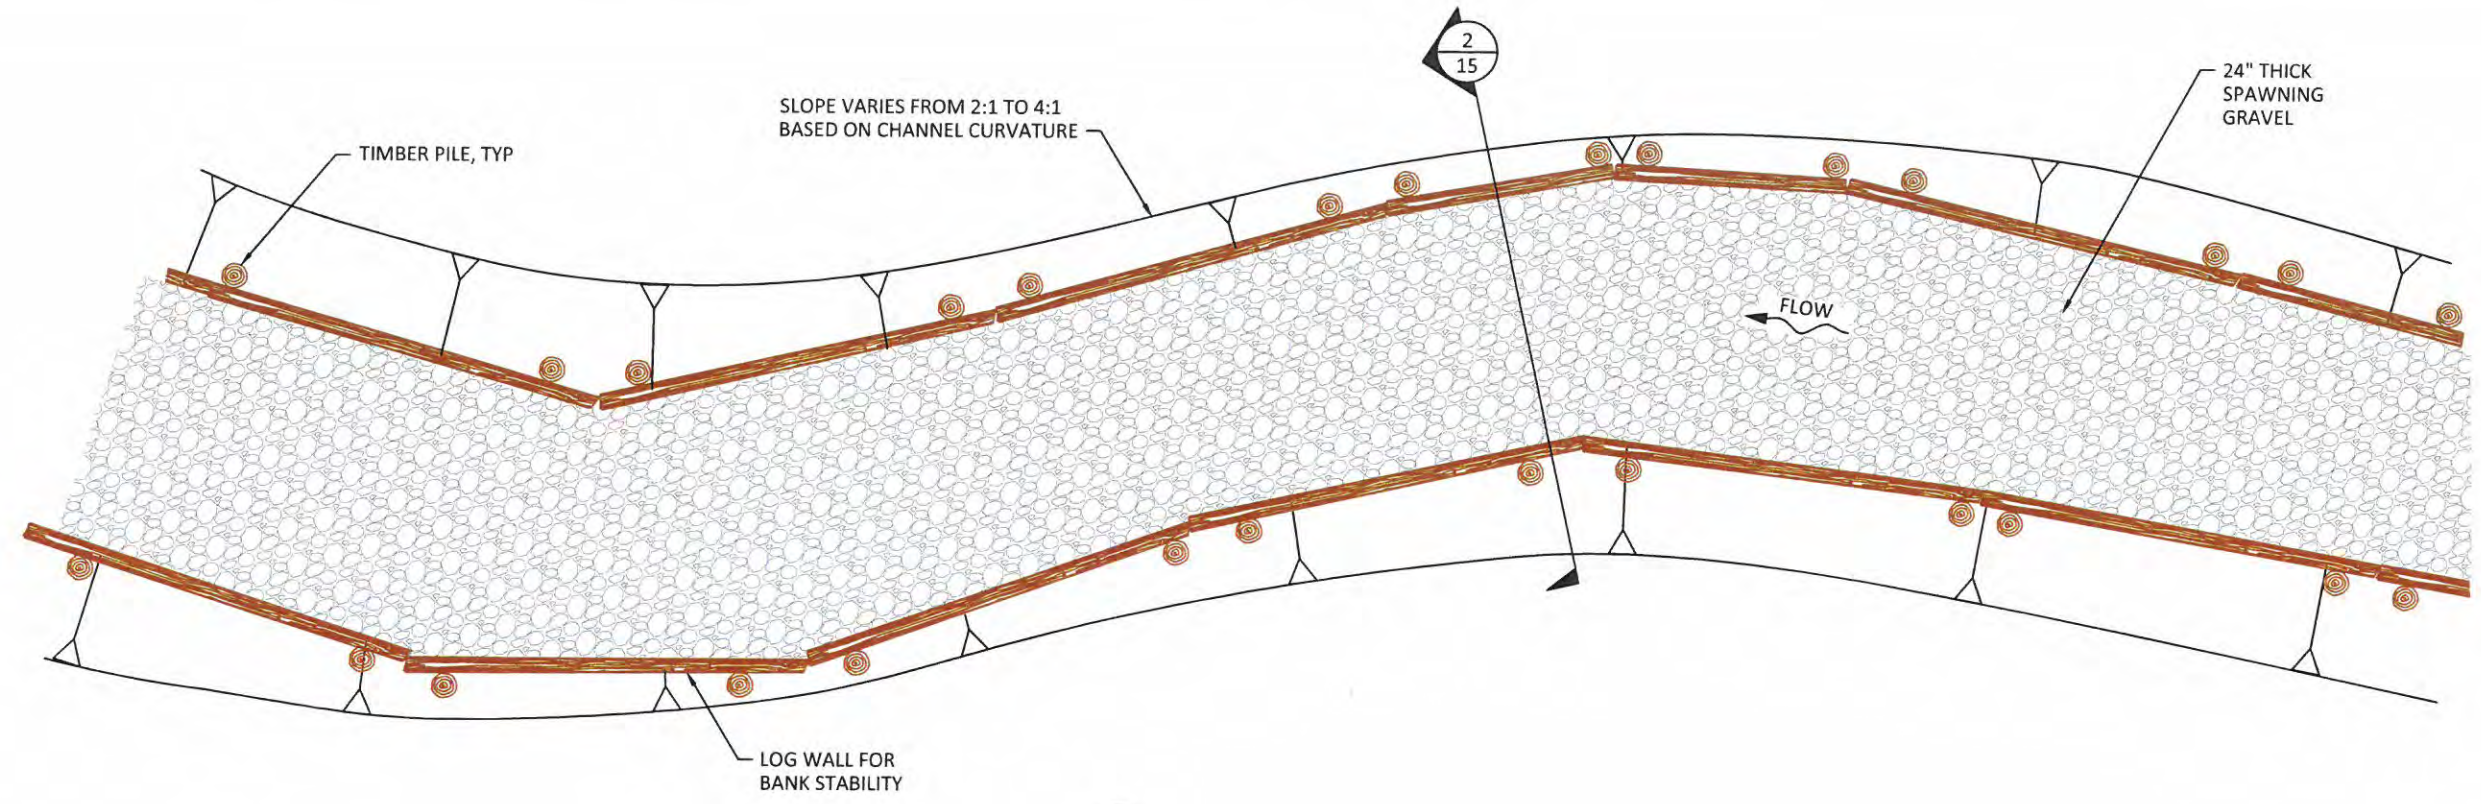

3 LOG TO PILE CONNECTION
15 NOT TO SCALE

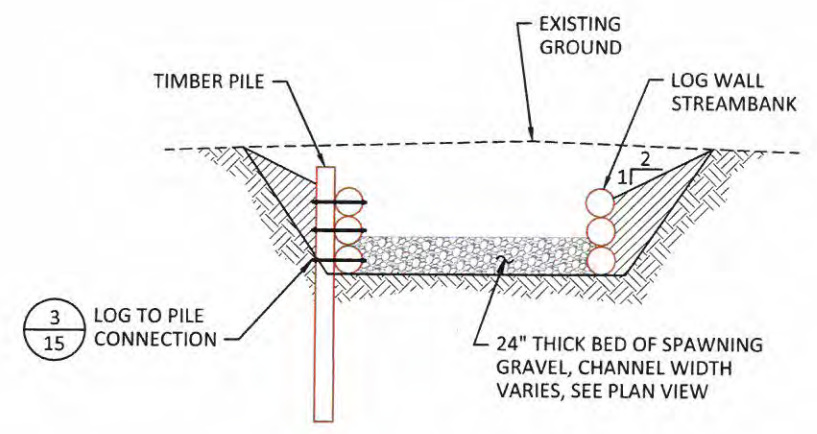

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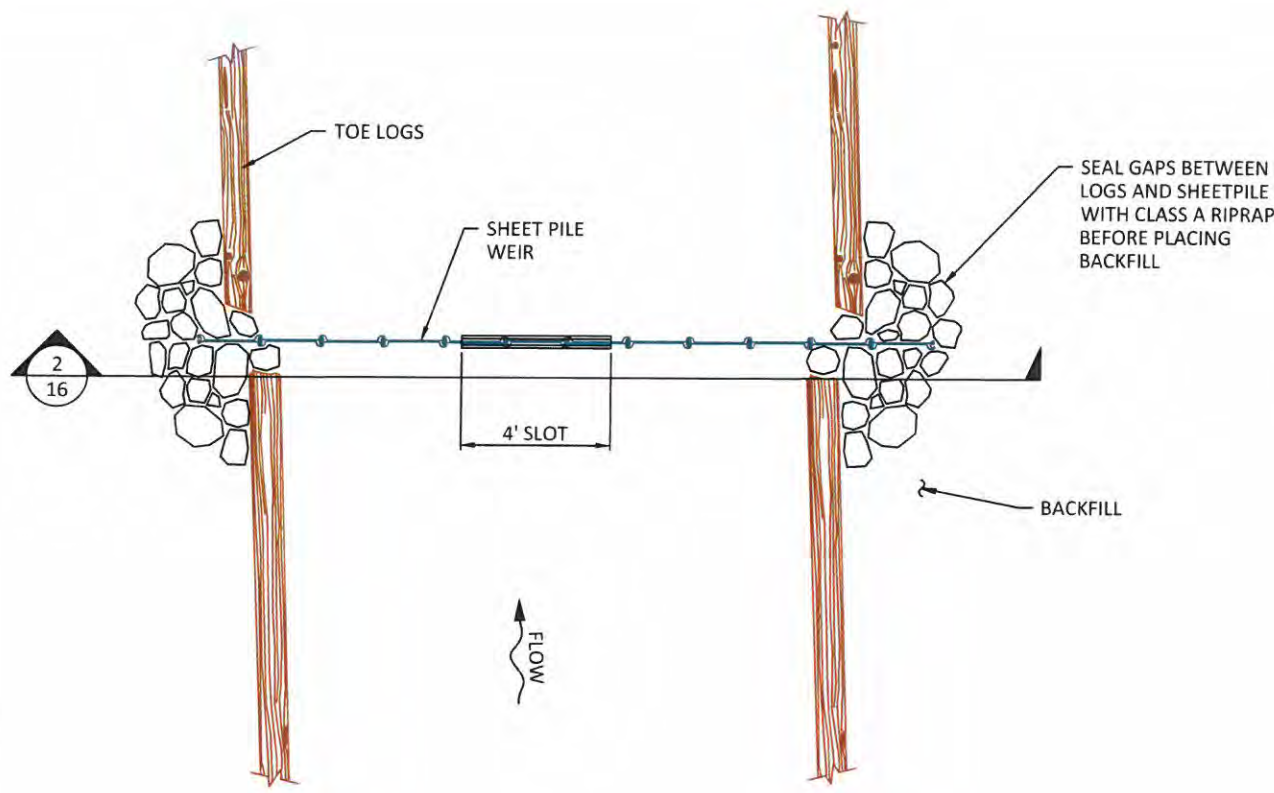
TYPICAL DETAILS

SHEET
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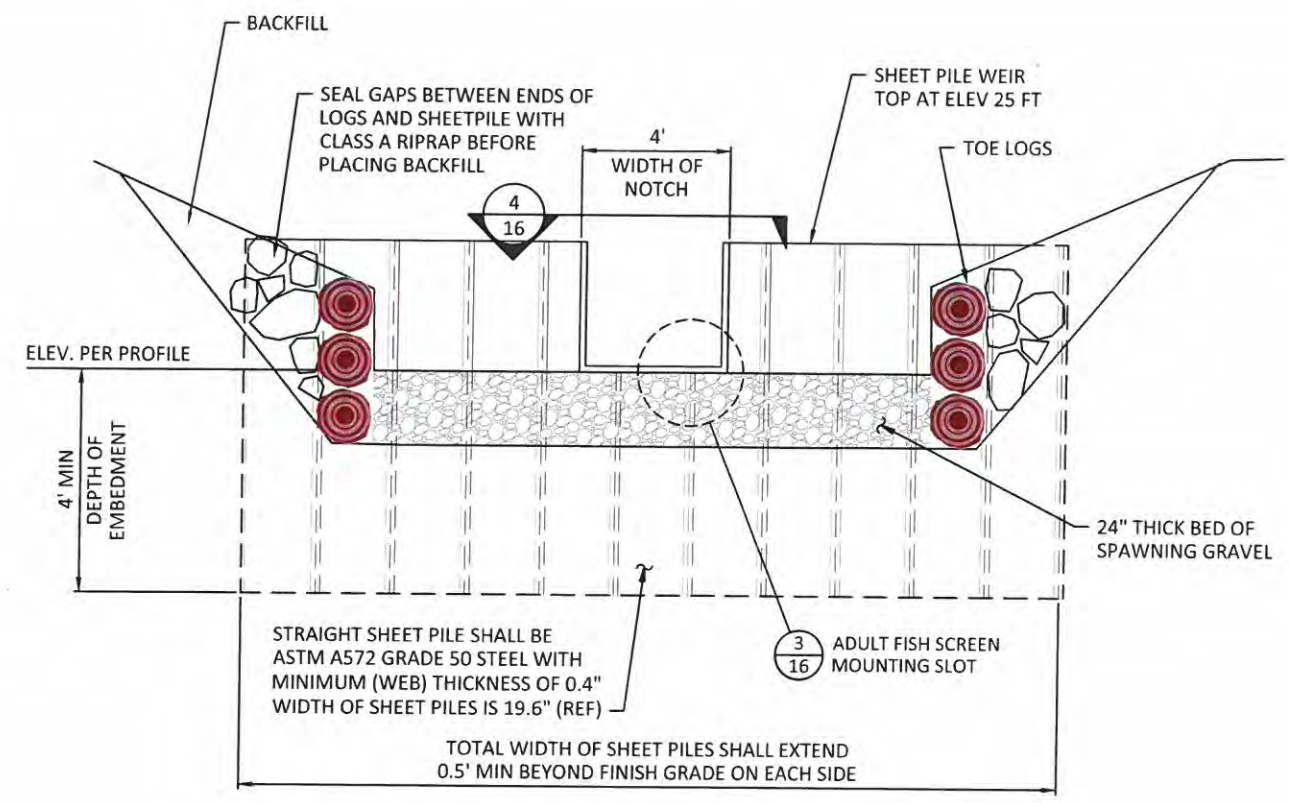
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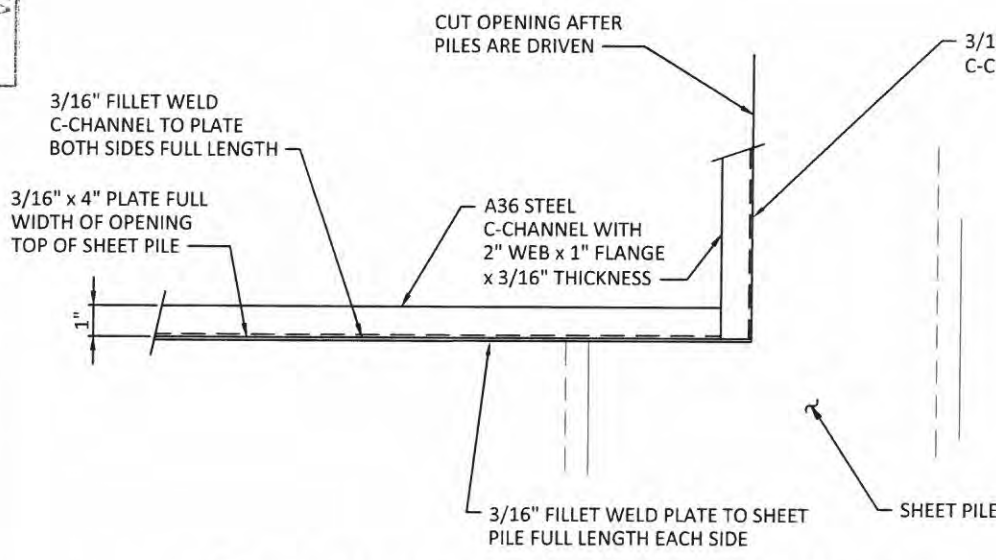
Approved Construction Plans
WOOD COUNTY, WA
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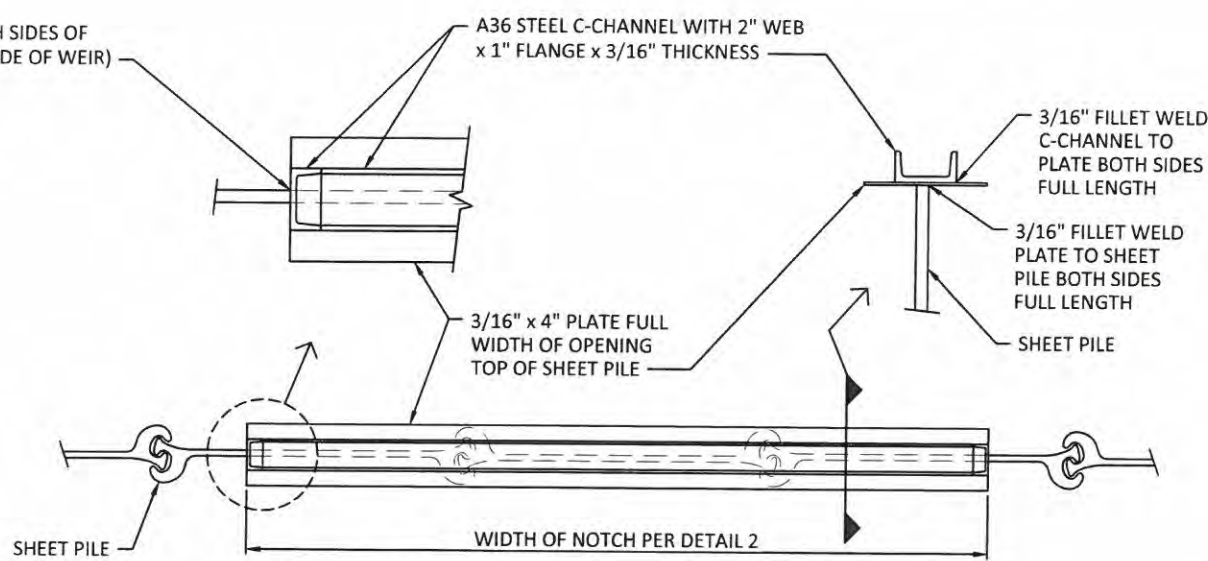
1 PLAN - CONTROL WEIR
16 NOT TO SCALE



2 SECTION - CONTROL WEIR
16 NOT TO SCALE



3 DETAIL AT CORNER OF FISH SCREEN SLOT
16 NOT TO SCALE



4 PLAN AT BOTTOM OF FISH SCREEN SLOT
16 NOT TO SCALE



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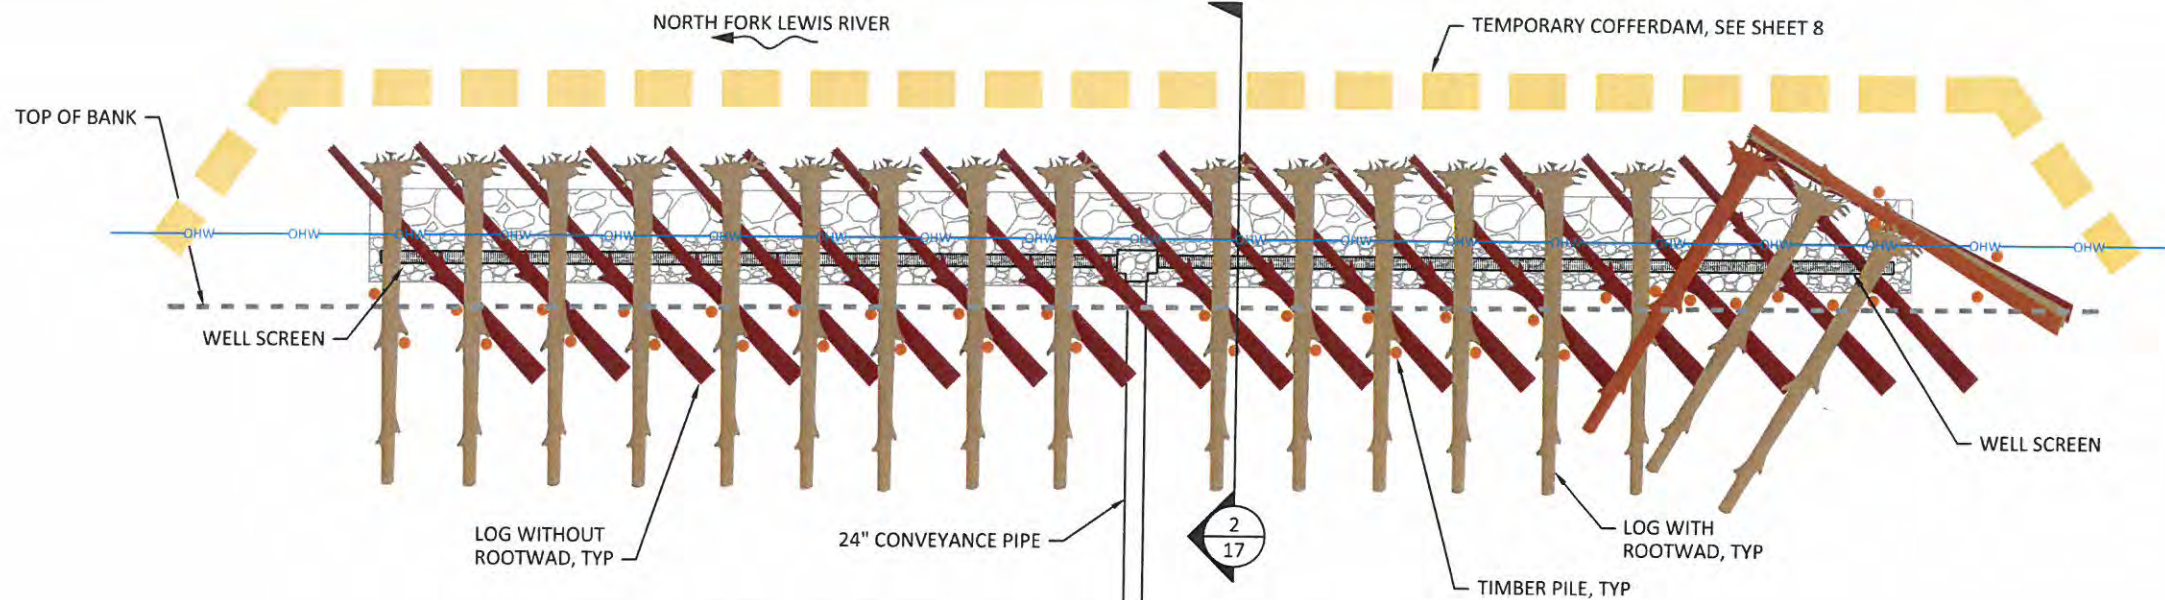
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CONTROL WEIR TYPICAL
DETAILS

SHEET
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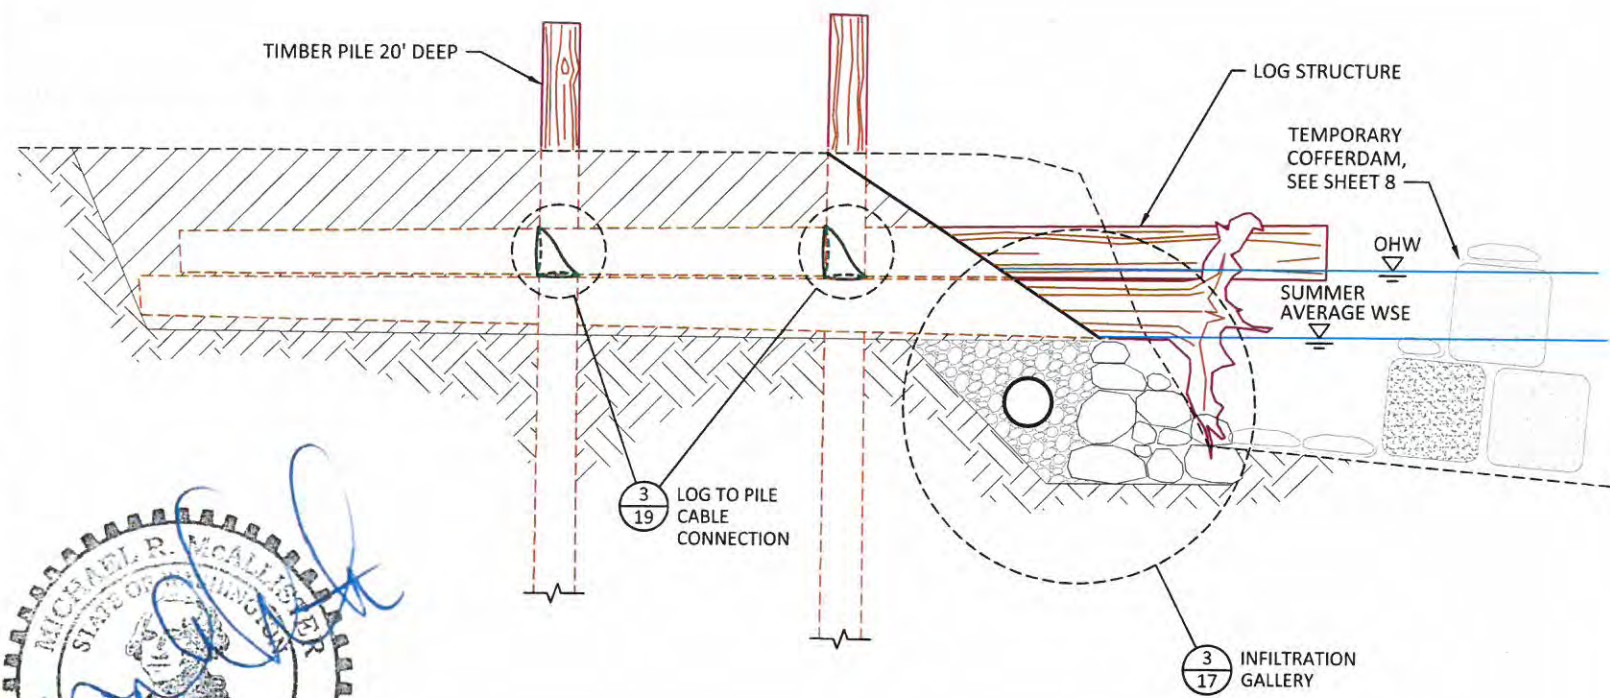


- LAYER 1
- LAYER 2
- LAYER 3
- VERTICAL SNAG


SEE $\frac{2}{18}$ FOR WELL
SCREEN, PIPE, FITTINGS,
AND APPURTENANCES.

**EROSION CONTROL
INSPECTION REQUIRED**
CALL 397-2375 EXT. 2499
BEFORE YOU BEGIN ANY SITEWORK

1 PLAN - WELL SCREEN AND LOG STRUCTURE
NOT TO SCALE



2 SECTION - WELL SCREEN AND LOG STRUCTURE
NOT TO SCALE

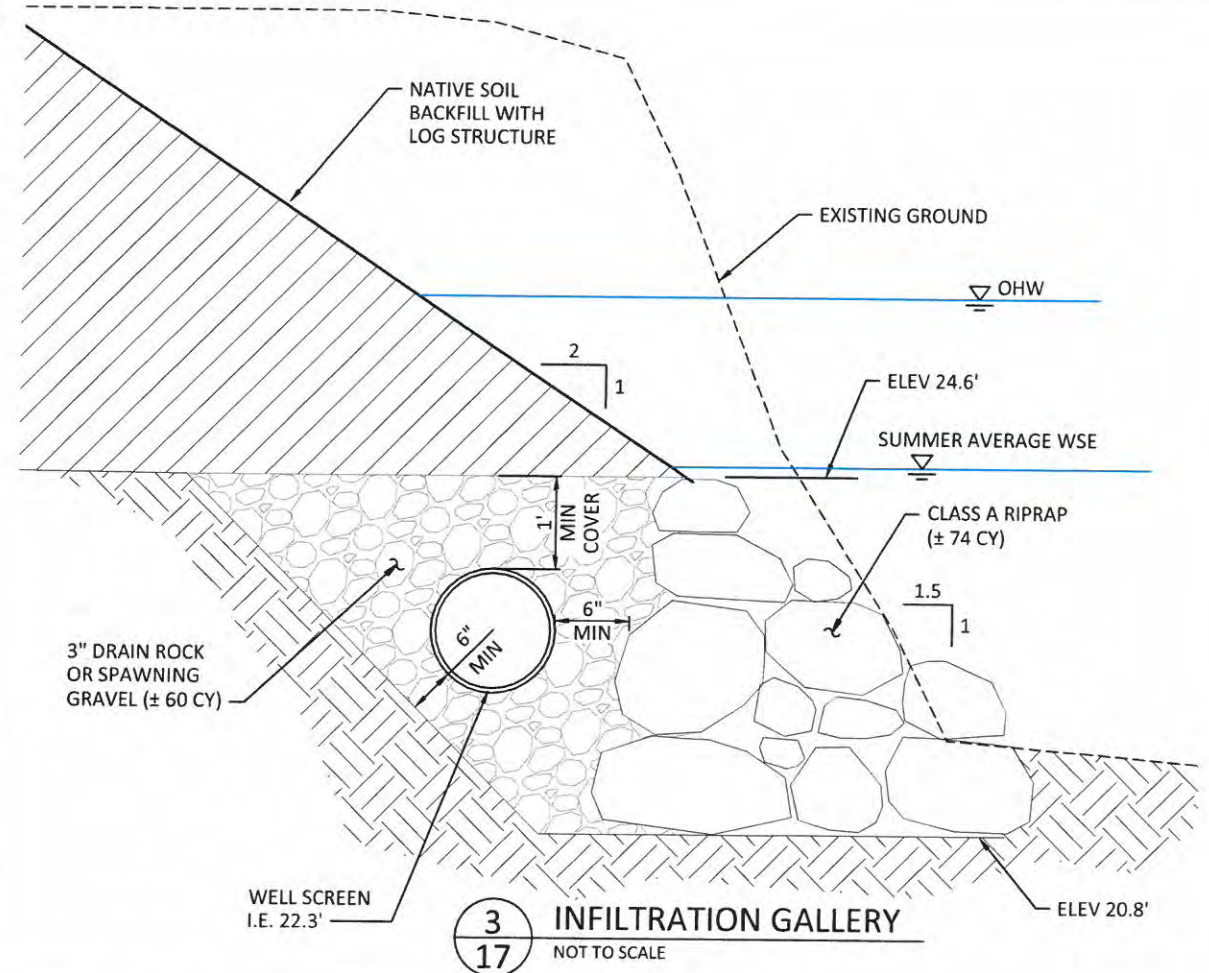

3 INFILTRATION GALLERY
NOT TO SCALE

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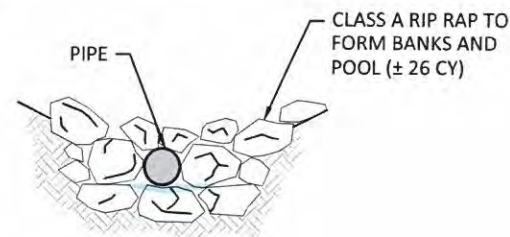
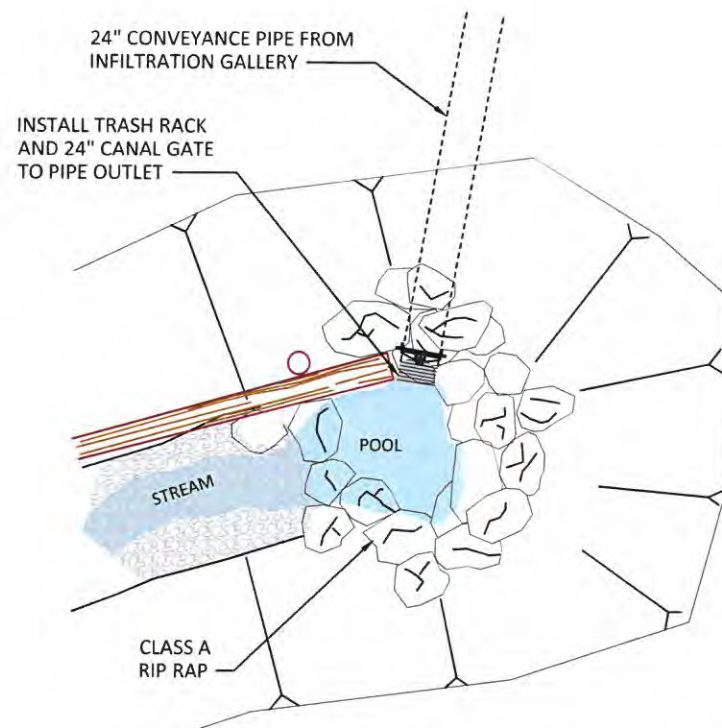
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TYPICAL DETAILS

SHEET
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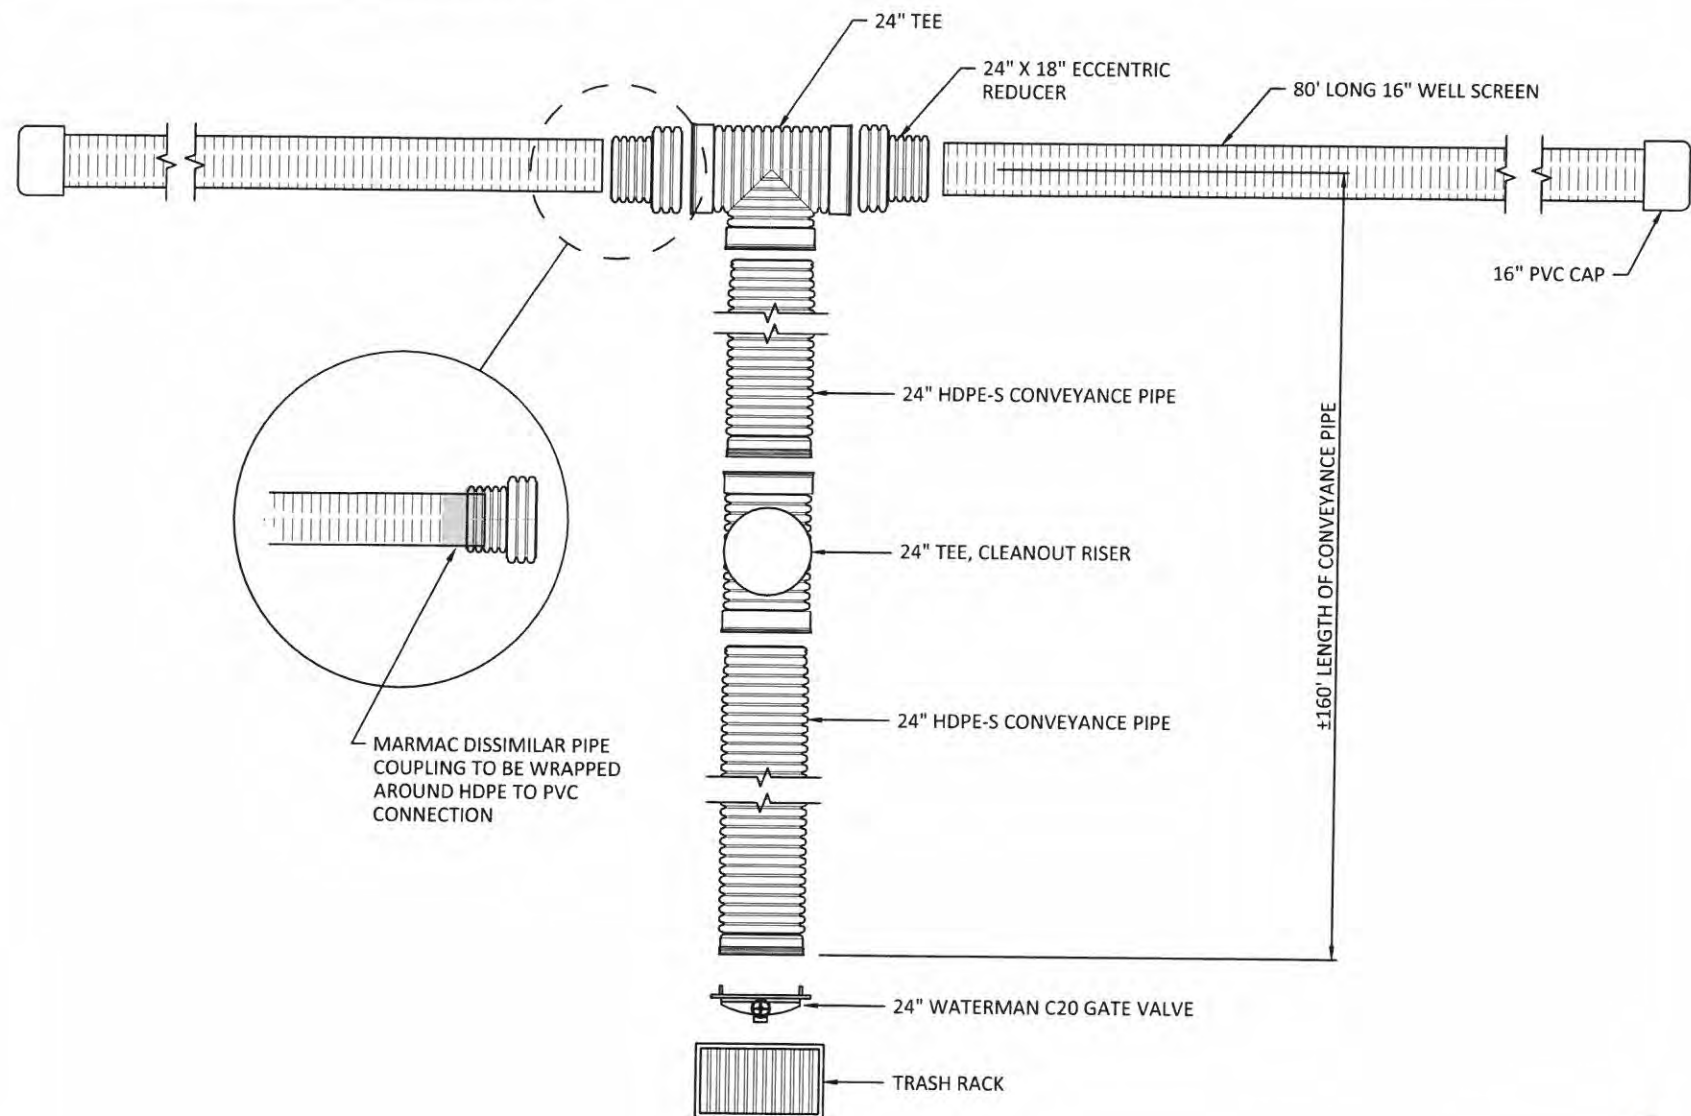
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1 PIPE OUTLET
18 NOT TO SCALE

WELLSCREEN
16" DIAMETER SCH40 OR SDR26
0.125" SLOTS, 0.25" SLOT SPACING, 10 ROWS PER FOOT
MINIMUM 133.1 SQ-IN OPEN AREA PER FOOT OF PIPE



2 WELL SCREEN PIPE AND FITTINGS
18 NOT TO SCALE




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18 OF 20




1
19 SECTION - TYPICAL FLOODPLAIN ROUGHNESS LWD
NOT TO SCALE

NOTES

FINAL ORIENTATION OF LOGS AND MATERIALS MAY VARY FROM TYPICAL DRAWINGS DEPENDING ON SIZE AND SHAPE OF MATERIAL DELIVERED OR SALVAGED.

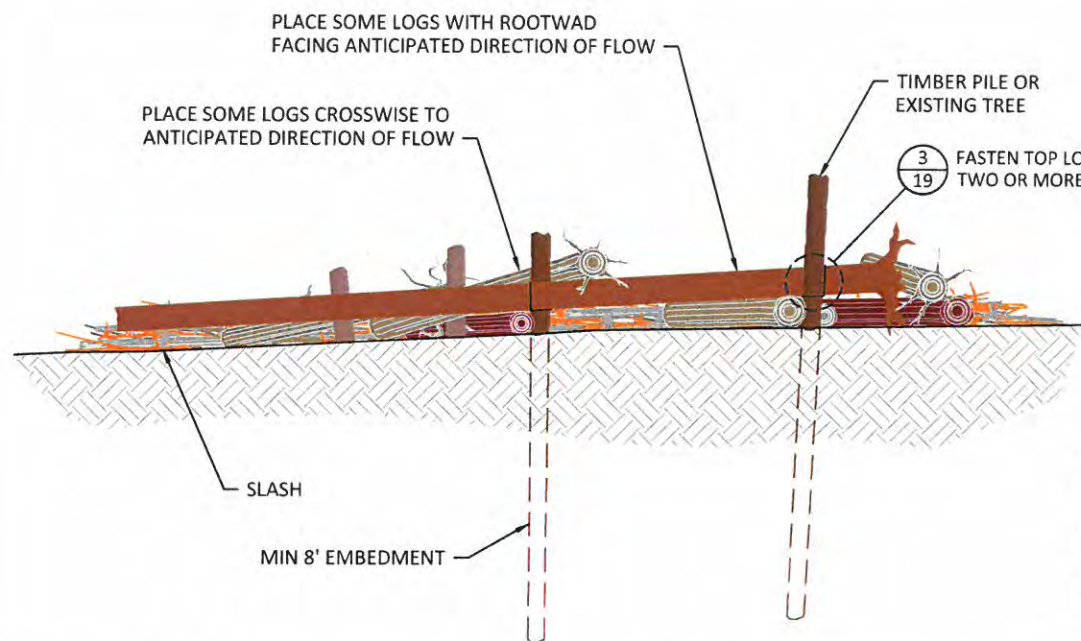
ALL REMOVED TREES AND WOODY VEGETATION SHALL BE SALVAGED AND STOCKPILED FOR USE AS FLOODPLAIN ROUGHNESS.

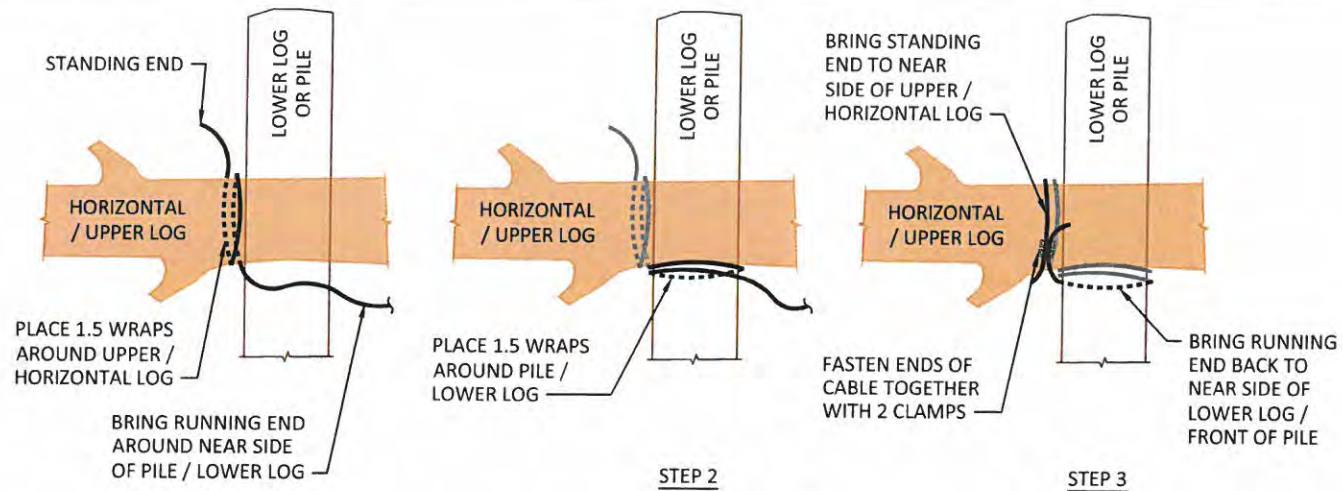


3
19 TYPICAL LOG CABLE CONNECTIONS
NOT TO SCALE

NOTES


1. USE 3/8 INCH GALVANIZED CABLE.
2. CABLE SHALL BE SECURED BY 1.5 WRAPS AROUND LOG AND SECURE TAG END WITH 2 CABLE CLAMPS
3. THERE SHALL BE NO SLACK IN THE CABLE AFTER IT IS FASTENED.
4. ADJUST LENGTH OF STANDING AND RUNNING ENDS SO THAT CLAMPS ARE LOCATED NEAR THE BOTTOM OF THE UPPER OR HORIZONTAL LOG.

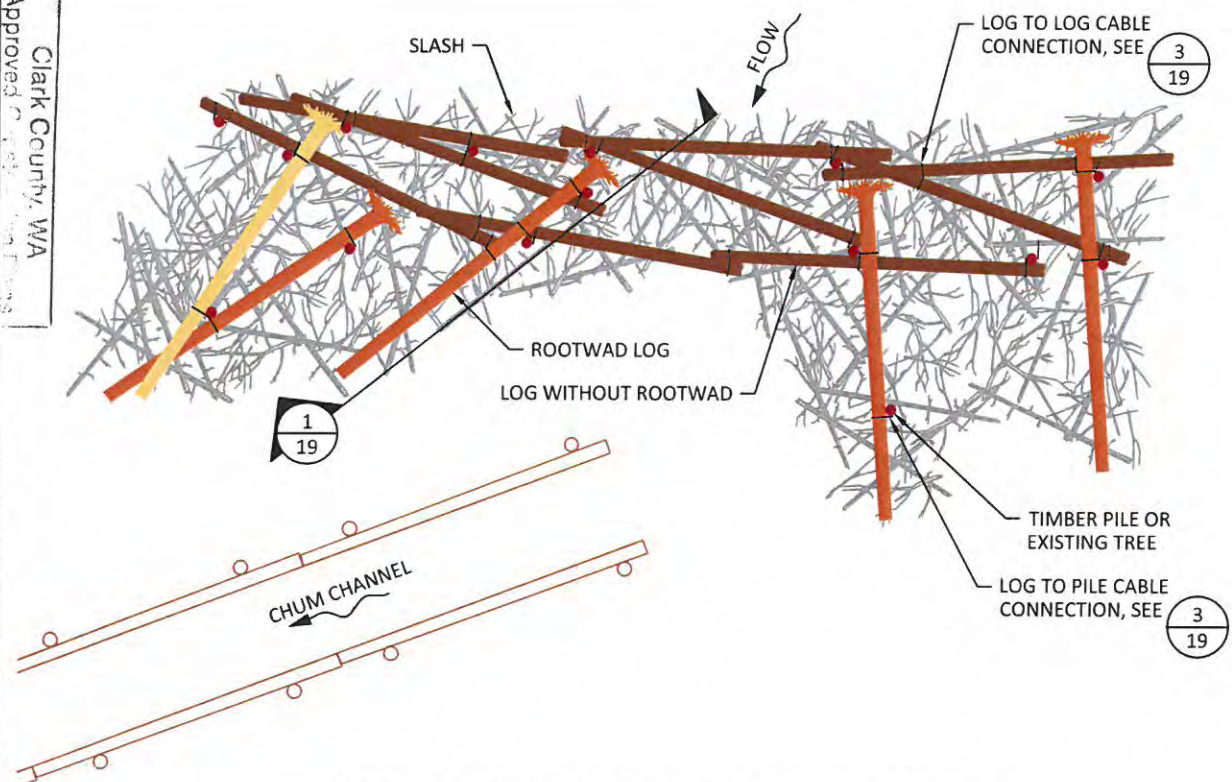

2
19 PLAN - FLOODPLAIN ROUGHNESS LWD
NOT TO SCALE

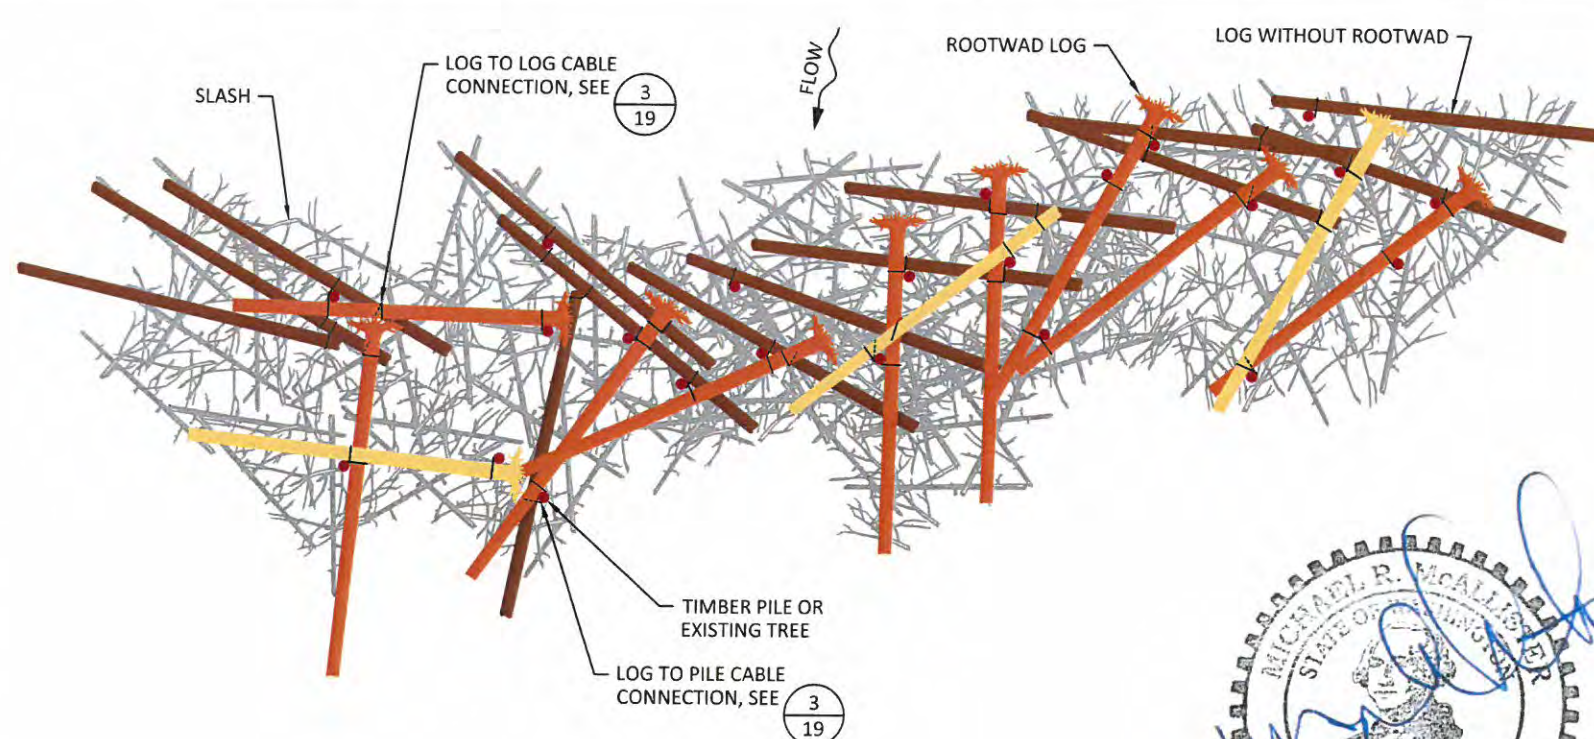

4
19 PLAN - FLOODPLAIN ROUGHNESS LWD
NOT TO SCALE

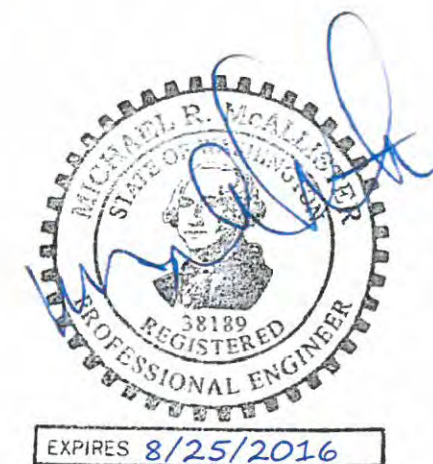

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 Approved: [Signature]
 Clark County, WA
 JUL 21 2016
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	MM	11-02-07	
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	DATE		
	PROJECT		

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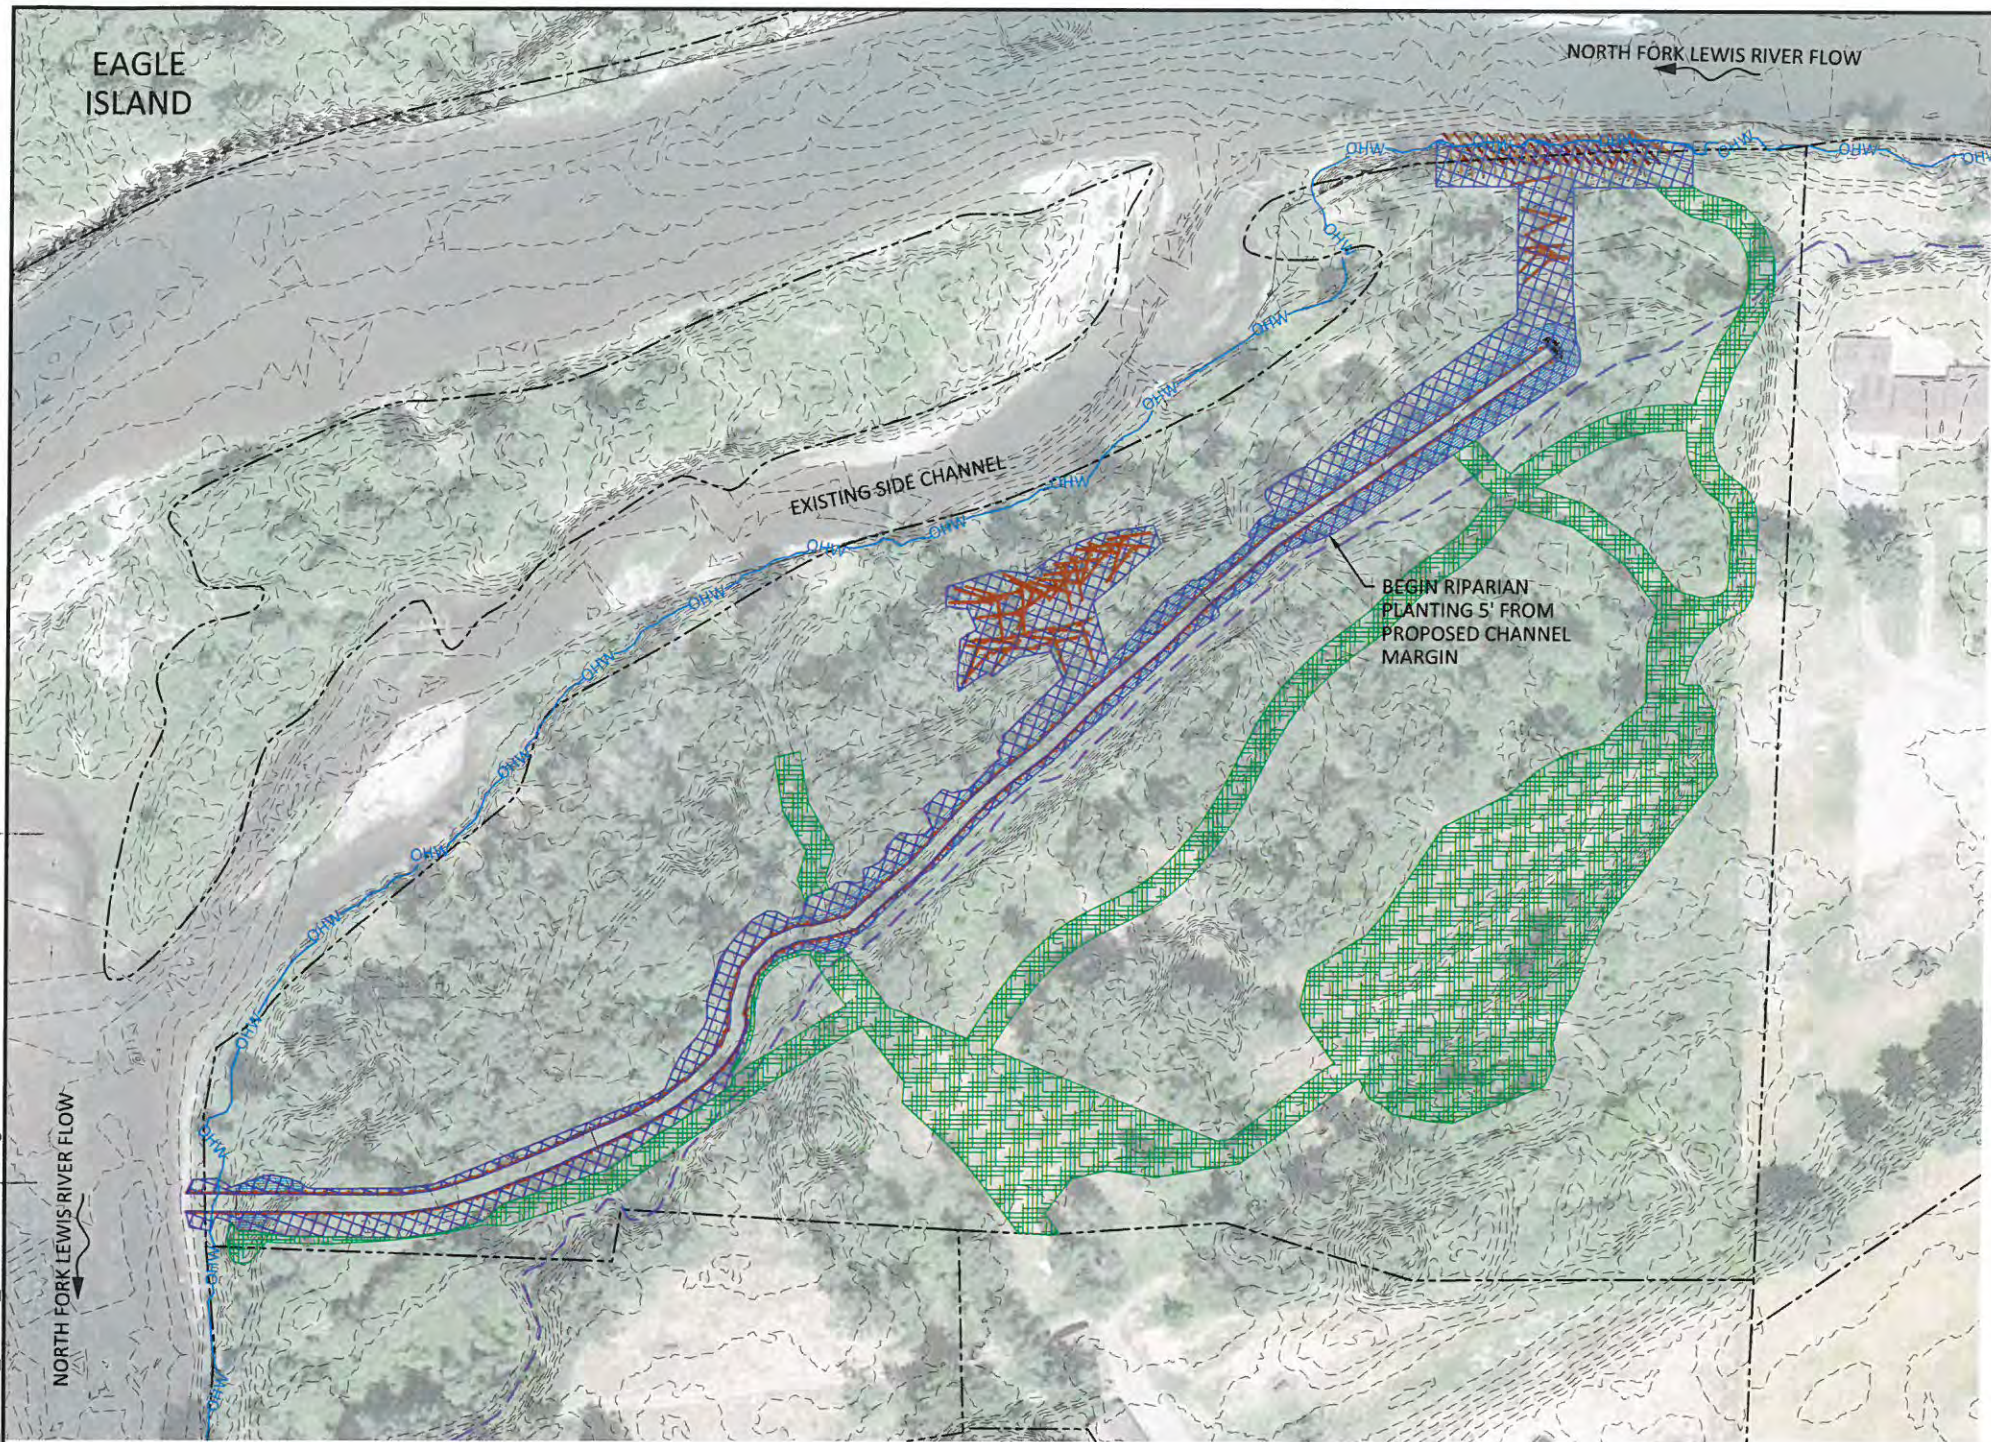
TYPICAL DETAILS

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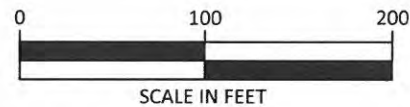
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PLAN



LEGEND

- PROPERTY LINES
- OHW — ORDINARY HIGH WATER
- - - EDGE OF FLOODPLAIN
- [Green cross-hatch] REVEGETATION AREA 1 - EROSION CONTROL SEED MIX
- [Blue cross-hatch] REVEGETATION AREA 2 - SHRUB & SMALL TREE PLANTINGS



NOTES:

- WEED-FREE STRAW MULCH MATERIAL SHALL BE PER SECTION 9-14.4(1) OF THE STANDARD SPECIFICATIONS AND SHALL BE APPLIED AT A RATE OF 3 TONS PER ACRE TO ALL DISTURBED AREAS FOLLOWING SEED APPLICATION.
- ACCESS ROUTES AND STAGING AREAS SHALL BE DECOMPACTED PRIOR TO APPLICATION OF SEED AND MULCH.
- SITE ACCESS ROADS AND OTHER DISTURBED AREAS TO BE SEEDED WITH 30-LBS. PER ACRE OF NATIVE EROSION CONTROL SEED MIX.
- REVEGETATION AREA 1 SHALL HAVE SEED AND STRAW MULCH APPLIED WITHIN 7 DAYS AFTER PROJECT COMPLETION.

Table 1. Revegetation Area #1 - Erosion Control Seeding 2.85 acres

Common Name	Scientific Name	Percentage of Mix
Blue Wildrye	<i>Elymus glaucus</i>	40%
Native Red Fescue	<i>Festuca rubra rubra</i>	40%
Tufted Hairgrass	<i>Deschampsia cespitosa</i>	10%
Sheep Fescue	<i>Festuca ovina</i>	5%
Quackgrass	<i>Agropyron repens</i>	5%

Table 2. Revegetation Area #2 – Riparian Plantings 1.46 acres

Common Name	Scientific Name	Plant Form	Min. Size	Qty
Trees - Approximate 10 foot spacing on center				
Oregon Ash	<i>Franxinus latifolia</i>	Bare root	24"	210
Cascara	<i>Rhamnus pushiana</i>	Bare root	24"	210
Black Cottonwood	<i>Populaus balsamifer ssp. Trichocarpa</i>	Bare root	24"	210
Shrubs - Approximate 4 foot spacing on center				
Red-Osier Dogwood	<i>Cornus Sericea</i>	Bare root	36"	400
Western Serviceberry	<i>Amelanchier alnifolia</i>	Bare root	36"	400
Black hawthorn	<i>Crateagus douglasii var. suksdorfii</i>	Bare root	36"	400
Pacific ninebark	<i>Physocarpus capitatus</i>	Bare root	36"	400
Indian plum	<i>Oemleria cerasiformis</i>	Bare root	36"	400
Thimbleberry	<i>Rubus parviflorus var. parviflorus</i>	Bare root	36"	400
Pacific willow	<i>Salix lucida</i>	Bare root	36"	400
Swamp Rose	<i>Rosa pisocarpa</i>	Bare root	36"	400

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REVEGETATION PLAN

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